



CAPTAIN JAMES A. LOVELL FEDERAL HEALTH CARE CENTER



Department of Veterans Affairs Department of the Navy

3001 N. GREEN BAY RD.
NORTH CHICAGO, IL 60064

REPLACE SURGICAL FLOORING PROJECT # 556-13-106

GENERAL
133-GI-001
133-GI-002

COVER SHEET
**GENERAL INFORMATION/SYMBOLS/
LOCATION**

ARCHITECTURAL
133-AI-001 **ARCHITECTURAL ABBREVIATIONS**
133-AI-101 **LIFE SAFETY PLAN**
133-AD-101 **DEMOLITION PLAN**
133-AS-101 **FLOOR PLAN**

133-AS-102 **FLOOR FINISH PLAN**
133-AS-103 **FLOOR FINISH PLAN - DEDUCTIVE
ALTERNATE NO. 2**
133-AS-201 **INTERIOR ELEVATIONS**
133-AS-501 **ARCHITECTURAL DETAILS**
133-AS-601 **ROOM FINISH SCHEDULE**

100% CONSTRUCTION DOCUMENTS

**BUILDING IS
FULLY
SPRINKLERED**

		CONSULTANTS:		ARCHITECT/ENGINEERS: COX DESIGN ASSOCIATES		Approved: Assistant Director Approved: Chief of Staff Approved: Chief, Engineering			Drawing Title COVER SHEET		Project Name REPLACE SURGICAL FLOORING		Project Number 556-13-106		Office of Construction and Facilities Management 				
				ARCHITECTURE PLANNING INTERIORS		Approved: Service Chief Approved: Chief, Bio-Med Approved: Chief, IT			Approved: Service Chief Approved: Chief, EMS Approved: Chief, M&O		Location CAPTAIN JAMES A. LOVELL FHCC 3001 GREEN BAY ROAD NORTH CHICAGO, IL 60064		Date AUGUST 7, 2013				Drawing Number 133-GI-001		
				Austin 5121 Bee Caves Road, Suite 203 Austin, Texas 78746 T: 512 - 327 - 4149 F: 512 - 327 - 7679 coxdesign@austin.tx.com		Chicago 345 N. Canal St. Suite 701 Chicago, IL 60605 T: 312 - 698 - 3880 F: 312 - 454 - 9439 bcx@coxtd.com			Approved: Chief, Safety Approved: Chief			Building Number 133-2C		Checked RHC			Drawn RAT		
Revisions:		Date															Dwg. of		

A

B

C

D

E

F

DISCIPLINE REFERENCES

DRAWINGS FOR THE FOLLOWING DISCIPLINES ARE CONTAINED IN THE DOCUMENT. THE DISCIPLINES ARE IDENTIFIED BY THE REFERENCE WHICH IS INCORPORATED INTO THE SHEET TITLE.

GI
D
A

GENERAL INFORMATION
DEMOLITION
ARCHITECTURAL

SHEET NUMBER

1-A1

BUILDING NUMBER

SHEET NUMBER
DISCIPLINE

DRAWING NUMBERING

1 BUILDING SECTION

REF: 1/1-A1

EACH DRAWING IS NUMBERED ACCORDING TO ITS LOCATION ON THE SHEET. THE DRAWING TITLE APPEARS ABOVE THE DEMARCATION LINE AND, APPROPRIATE THE SCALE IS LOCATED BELOW THE DEMARCATION LINE IN THE LOWER LEFT-HAND QUADRANT OF THE KEY. THE DRAWING CAN BE REFERENCED BACK TO ITS ORIGINAL SHEET AND DRAWING BY THE DRAWING REFERENCE LOCATION IN THE LOWER RIGHT-HAND QUADRANT.

DRAWING REFERENCE

RE: 1/1-A26

SHEET NUMBER

DRAWING NUMBER ON SHEET BY LOCATION

REFERENCE

PROJECT SHEET NOTES

A. REFER TO SHEET 133-GI-002 FOR STANDARD SYMBOLS

B. REFER TO SHEET 133-GI-002 FOR PROJECT GENERAL NOTES

C. FOR LIFE SAFETY CODE ANALYSIS AND PLANS REFER TO SHEET 133-AI-101

D. FOR ARCHITECTURAL GENERAL NOTES, ABBREVIATIONS, SYMBOLS, DIMENSIONING CONVENTIONS REFER TO SHEET 133-GI-002

E. FOR ARCHITECTURAL MATERIAL/FINISH DESIGNATIONS REFER TO MATERIAL LEGEND ON SHEET 133-AS-601

ARCHITECTURAL FLOOR PLAN SYMBOLS

CENTER LINE

ELEVATION INDICATOR

CENTER LINE INDICATOR

DEMOLITION LINE

EXISTING TO REMAIN LINE

FEATURES ABOVE LINE INDICATOR

CONSTRUCTION LIMITS

BREAK, ROUND (USER DEFINES SIZE)

BREAK, STRAIGHT (SEE SECTION INDICATORS)

DETAIL INDICATOR

DETAIL INDICATOR

DIMENSION LINE

INTERIOR ELEVATION

ELEVATION NOT PRESENT

ELEVATION PAGE NUMBER

ELEVATION DETAIL NUMBER

DETAIL REFERENCE

PAGE DIRECTION

PAGE DETAIL NUMBER

DETAIL PAGE NUMBER

WALL SECTION INDICATOR

PAGE DETAIL NUMBER

DETAIL PAGE NUMBER

BUILDING SECTION INDICATOR

PAGE DIRECTION

PAGE DETAIL NUMBER

DETAIL PAGE NUMBER

PLAN NOTE

KEYNOTE / WALL TYPE / PARTITION TYPE

ROOM TITLE

ROOM NAME

ROOM NUMBER

GROSS SF FROM INTERIOR FINISH (IF APPLICABLE)

COLUMN GRID

NORTH ARROW

REVISION NUMBER AND EXTENT

REVISION NUMBER - SEE REVISION HISTORY ON THE TITLE BLOCK OF EACH SHEET

EXTENT OF CURRENT REVISION

KEYED NOTE MARK - SEE CORRESPONDING NUMBERED KEY NOTE ON SHEET WHERE REFERENCE OCCURS

MATERIAL GRAPHICS

CONCRETE

EXISTING MASONRY

GYP BD

BUILDING INTERIOR

EXISTING TO REMAIN

GENERAL NOTES

1. VERIFY ALL DIMENSIONS AND CONDITIONS A.Y. JOB SITE.

2. UNLESS NOTED TO BE REMOVED AND DISPOSED, ALL EXISTING ITEMS ARE TO REMAIN. THEY SHALL BE PROTECTED FROM DAMAGE DUE TO CONSTRUCTION ACTIVITIES. ANY EXISTING ITEMS TO REMAIN THAT BECOME DAMAGED DUE TO CONSTRUCTION ACTIVITIES SHALL BE REPAIRED OR REPLACED TO MATCH EXISTING AT NO ADDITIONAL COST TO THE OWNER..

3. MAINTAIN CONTINUOUS UTILITY SERVICE TO ALL SPACES IN THE BUILDING NOT AFFECTED BY THIS WORK. COORDINATE WITH OWNER ANY DISRUPTION IN SERVICES REQUIRED TO PERFORM WORK OR TO MODIFY EXISTING PIPING, DUCTWORK, OR ANY ASSOCIATED EQUIPMENT.

4. THE GENERAL CONTRACTOR SHALL REPORT ANY UNFORESEEN FIELD CONDITIONS, ERRORS, INCONSISTENCIES, OR OMISSIONS DISCOVERED AT ANY TIME DURING THE WORK, UPON SUCH DISCOVERY, THE CONTRACTOR SHALL IMMEDIATELY CONTACT THE C.O.R. FOR CLARIFICATION BEFORE PROCEEDING OR CONTINUING WITH THAT PORTION OF THE WORK OR ANY PORTION RELATED THERE TO.

5. ALL WORK SHALL CONFORM TO ALL APPLICABLE CODES AND STANDARDS INCLUDING THE INTERNATIONAL BUILDING CODE 2012 EDITION, VA MASTER SPECIFICATIONS, AND NFPA 101 2012 EDITION.

6. CONTRACTOR SHALL NOT BARRICADE / BARRIER EMERGENCY EGRESS TO OR FROM THIS AREA. CONTRACTOR SHALL MAINTAIN EXIT TO EXTERIOR DURING THE WORK PROCESS

7. PROVIDE ACCESS TO THE WORK AS DIRECTED BY THE C.O.R. SECURE ACCESS POINT AS SPECIFIED AND DIRECTED BY THE COR PROJECT ENGINEER. PROVIDE WALK-OFF MATS TO MEET FACILITY INFECTION CONTROL GUIDELINES AT EACH ACCESS POINT.

8. SHADED AREAS ARE GENERALLY OUT OF SCOPE FOR THIS PROJECT.

9. NOTATIONS FOR ITEMS OF WORK APPLY TO EACH AND EVERY GRAPHICAL INDICATION SHOWN ON THE DRAWINGS, WHETHER OR NOT NOTED.

10. THE GENERAL CONTRACTOR SHALL VISIT THE SITE, VERIFY FIELD CONDITIONS AND CAREFULLY COMPARE SUCH FIELD CONDITIONS AND OTHER INFORMATION KNOWN TO THE CONTRACTOR WITH CONTRACT DOCUMENTS.

11. THE GENERAL CONTRACTOR SHALL REPORT ANY UNFORESEEN FIELD CONDITIONS, ERRORS, INCONSISTENCIES, OR OMISSIONS DISCOVERED AT ANY TIME DURING THE WORK, UPON SUCH DISCOVERY, THE CONTRACTOR SHALL IMMEDIATELY CONTRACT THE ARCHITECT AND PROJECT ENGINEER FOR CLARIFICATION BEFORE PROCEEDING OR CONTINUING WITH THAT PORTION OF THE WORK OR ANY PORTION RELATED THERE TO.

12. THE GENERAL CONTRACTOR SHALL NOTIFY THE PROJECT ENGINEER AND THE ARCHITECT OF ANY DISCREPANCIES BETWEEN THE DRAWINGS, NOTES AND ACTUAL FIELD CONDITIONS BEFORE BIDDING AND COMMENCING ANY WORK, AND REQUEST CLARIFICATION IN WRITING.

13. WORK SHALL BE PERFORMED DURING THE FOLLOWING HOURS:
MONDAY THROUGH THURSDAY - 1800 TO 0500 EACH DAY
WEEKENDS - FRIDAY 1800 TO MONDAY 0500

ARCHITECT/ENGINEERS:

COX DESIGN ASSOCIATES

ARCHITECTURE PLANNING INTERIORS

Austin 5121 Bee Caves Road, Suite 203 Austin, Texas 78746 T:512 - 327 - 4149 F:512 - 327 - 7679 coxdesign@austin.tx.com

Chicago 345 N. Canal St. Suite 701 Chicago, IL 60605 T:312 - 698 - 3880 F:312 - 454 - 9439 bcocx@coxtd.com

DIMENSIONING CONVENTIONS

1. EXCEPT WHERE DIRECTED TO PLACE ITEMS OF THE WORK AT THE "APPROXIMATE LOCATION SHOWN," DO NOT SCALE DRAWINGS FOR DIMENSIONAL INFORMATION

2. ALL ELEMENTS OF THE DOCUMENTS MAY NOT BE DRAWN TO EXACT SCALE. ALL DIMENSIONS REQUESTED ARE SHOWN (OR MAY BE DERIVED FROM THOSE SHOWN OR NOTED) ON THE FLOOR PLANS. DETAIL PLANS, ELEVATIONS, SECTIONS, SCHEDULES, CONFIGURATION DETAILS, AND SPECIFICATIONS. SEE THE NOTES BELOW AND SYMBOLS FOR DIMENSIONING CONVENTIONS USED ON THIS PROJECT.

3. EXCEPT WHERE SPECIFICALLY NOTED TO THE CONTRARY, ALL DIMENSIONS SHOWN ON THE ARCHITECTURAL DRAWINGS CONFORM TO THE FOLLOWING CONVENTIONS.

A. DIMENSIONS UTILIZING THE "CENTERLINE" SYMBOL ARE MEASURED TO:

- CENTERLINE OF PARTITION ASSEMBLY (EXCLUSIVE OF ANY APPLIED FINISHES HAVING THICKNESS WHICH MAY BE ADDED TO SUCH WALLS) AT PARTITIONS FRAMED WITH METAL STUDS. REFER TO "PARTITION SCHEDULE" TO DETERMINE THICKNESS OF EACH PARTITION TYPE.
- CENTERLINE OF DOOR, WINDOW, OR LOUVER OPENING.
- CENTERLINE OF OTHER FEATURES AS INDICATED.

B. DIMENSIONS UTILIZING THE "FACE OF" SYMBOL ARE MEASURED TO:

- FACE OF PARTITION ASSEMBLY (EXCLUSIVE OF ANY APPLIED FINISHES HAVING THICKNESS WHICH MAY BE ADDED TO SUCH WALL) AS DEFINED BY THE PARTITION SCHEDULE. UNLESS NOTED AS A "FACE OF FINISH" OR "CLEAR" DIMENSION, DIMENSIONS ARE NOT MEASURED TO THE FACE OF APPLIED FINISH. REFER TO THE "PARTITION SCHEDULE" TO DETERMINE THE THICKNESS OF EACH PARTITION TYPE.

C. WHERE "EQUAL" DIMENSIONS ARE USED ON REFLECTED CEILING PLANS TO LOCATE CEILING GRID WORK POINTS, MEASURE DIMENSIONS TO:

- EDGE OF THE INDICATED CEILING AT THE FACE OF THE ADJACENT APPLIED FINISH MEASURED AT THE PLANE OF THE CEILING.
- CAUTION: DUE TO THE POSSIBLE APPLICATION OF APPLIED FINISHES - THICKNESS OF WHICH MAY VARY BETWEEN FLOOR AND CEILING AND IS NOT ACCOUNTED FOR (EXCEPT AS INDICATED BY "FOF" OR "CLEAR") BY THE DIMENSION SHOWN ON THE FLOOR PLANS - THE CONTRACTOR MUST ADJUST AS NECESSARY, THE FLOOR PLAN DIMENSIONS TO REFLECT THE ACTUAL DIMENSIONS FOUND AT PLANE OF THE CEILING.

4. WHERE WALLS AND/OR PARTITIONS OF UNEQUAL THICKNESS ABUT, ALIGN EXPOSED FACES, UNLESS OTHERWISE NOTED.

ALIGN

DIMENSION, WHEN OCCURS

5. WHERE OPENINGS IN WALLS (SUCH AS INTERIOR WINDOWS OR DOORS) ARE NOT DIMENSIONED BUT SHOWN AS BEING IN THE CENTER OF A GIVEN WALL SURFACE, LOCATE OPENINGS AS GRAPHICALLY REPRESENTED.

LOCATION MAP

NTS

BUILDING IS FULLY SPRINKLERED

PROJECT INFORMATION

CODES:

INTERNATIONAL BUILDING CODE

OCCUPANCY:

GROUP I-2

TYPE OF CONSTRUCTION:

UNPROTECTED, TYPE I-332 FULLY SPRINKLERED

PROJECT AREA:

2ND FLOOR RENOVATION: 6,320 GSF

Drawing Title

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Location

CAPTAIN JAMES A. LOVELL FHCC
3001 GREEN BAY ROAD
NORTH CHICAGO, IL 60064

Project Name

REPLACE SURGICAL FLOORING

Building Number

133-2C

Checked

RHC

Drawn

RAT

Project Number

556-13-106

Date

AUGUST 7, 2013

Drawing Number

133-GI-002

Dwg.

of

Office of Construction and Facilities Management

Department of Veterans Affairs

Revisions:

Date

CONSULTANTS:

ARCHITECT/ENGINEERS:

COX DESIGN ASSOCIATES

ARCHITECTURE PLANNING INTERIORS

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Approved: Assistant Director

Approved: Chief of Staff

Approved: Chief, Engineering

Approved: Service Chief

Approved: Service Chief

Approved: Service Chief

Approved: Chief, Bio-Med

Approved: Chief, EMS

Approved: Chief, Infection Control

Approved: Chief, IT

Approved: Chief, M&O

Approved: Chief, Police

Approved: Chief, Safety

Approved: Chief

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A

B

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A

B

C

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E

F

three inches = one foot

one and one half inches = one foot

one inch = one foot

three quarters inch = one foot

one half inch = one foot

three eighths inch = one foot

one quarter inch = one foot

one eighth inch = one foot

1

2

3

4

5

6

7

8

9

VA FORM 08-6231

ARCHITECTURAL ABBREVIATIONS

A	<div>three inches = one foot</div>	A LABEL	CLASS A DOOR	COL	COLUMN	FLR SK	FLOOR SINK	LS	LUMP SUM	PO	PURCHASE ORDER POST OFFICE	STRUCT STL	STRUCTURAL STEEL
		A/C	AIR CONDITION	COM	COMMON	FLOOR	FLUORESCENT	LT	LIGHT	POLY	POLYETHYLENE (PLASTIC)	SUB	SUBSTITUTE
		A/C UNIT	AIR CONDITIONING UNIT	COMB	COMBINATION, COMBINED	FLUOR FIX	FLUORESCENT FIXTURE	LT GA	LIGHT GAGE	PR	PRECAST	SURF	SURFACE
B	<div>one and one half inches = one foot</div>	A/E	ARCHITECT/ENGINEER	COMM	COMMUNICATION	FM	FACTORY MUTUAL	LTG	LIGHTWEIGHT	PRCST	PRECAST	SUSP	SUSPEND
		A/MA	AMERICAN ARCHITECTURAL MANUFACTURERS ASSOCIATION	COMP	COMPONENT	FM G	FACTORY MUTUAL GLOBAL	LTG AB	LIGHTING	PRCST AB	PRECAST	SUSP CLG	SUSPENDED CEILING
		AB	ANCHOR BOLT	CONC	CONCRETE	FO	FINISHED OPENING	LTNG	LIGHTNING	PREFIN	PREFINISH	SV	SHEET VINYL
C	<div>one inch = one foot</div>	ABC	ASBESTOS BASE COURSE	CONC FLR	CONCRETE FLOOR	FOC	FACE OF CONCRETE OR FACE OF CURB	LVD	LOUVERED	PRELIM	PRELIMINARY	SW	SWITCH
		AC	ASBESTOS CEMENT OR ASPHALTIC CONCRETE	COND	CONDENSER OR CONDITION	FOM	FACE OF MASONRY	LVR	LOUVER	PREP	PREPARATION	SWDR	SWINGING DOOR
		ACI	AMERICAN CONCRETE INSTITUTE	CONF	CONFERENCE	FOS	FACE OF SLAB OR FACE OF STUD	LWC	LIGHTWEIGHT CONCRETE	PRESS	PRESSURE	SYM	SYMBOL
D	<div>three quarters inch = one foot</div>	ACM	ASBESTOS CONTAINING MATERIAL	CONN	CONNECT	FOS CNT	FACE OF STUD	LWIC	LIGHTWEIGHT INSULATING CONCRETE LAYER	PREV	PREVIOUS	SYNTH	SYNTHETIC
		ACP	ACRYLIC GLAZING	CONSTR	CONSTRUCTION	FOW	FACE OF WALL	LYR	LAYER	PRMG	PREMOLD	SYSTM	SYSTEM
		ACS DR	ACCESS DOOR	CONT	CONTINUE	FP	FIRE PROTECTION OR FIREPROOF	MACH	MACHINE	PRMLD	PREMOLD	T&G	TONGUE AND GROOVE
E	<div>one half inch = one foot</div>	ACS FLR	ACCESS FLOOR	COORD	COORDINATE	FM	FEET PER SECOND	MACH RM	MACHINE ROOM	PROJ	PROJECT	T&M	TIME AND MATERIALITY
		ACS PNL	ACCESS PANEL	CORR	CORRIDOR	FPS	FEET PER SECOND	MAINT	MAINTENANCE	PROP	PROPOSE	TB	THROUGH BOLT OR TOWEL BAR
		ACST	ACOUSTIC	CORR	CORRIDOR	FR	FIRE RATING, FIRE RESISTANT, OR FRAME	MAN	MANUAL	PSI	POUNDS PER SQUARE INCH	TCA	TILE COUNCIL OF AMERICA
F	<div>one eighth inch = one foot</div>	AD	AREA DRAIN	CSG	CONCRETE SPLASH BLOCK	FR SSK	FRUSHING RIM SINK	MATV	MATERIAL	PT	PAINT	TECH	TECHNICAL
		ADA	AMERICANS WITH DISABILITIES ACT	CSP	CARPET	FREQ	FREQUENCY	MAX	MAXIMUM	PVC	POLYVINYL CHLORIDE (PLASTIC)	TEMP	TEMPERATURE OR TEMPORARY
		ADDL	ADDITIONAL	CSG	CASING	FRM	FRAMING	MCB	MACHINE BOLT	PTD	PAPER TOWEL DISPENSER	TER	TERRAZZO
G	<div>one quarter inch = one foot</div>	ADDN	ADDITION	CSG	CASING	FRP	FIBERGLASS REINFORCED PLASTIC	MD	DECK	PVG	PAVING	THD	THREAD
		ADH	ADHESIVE	CSG	CASING	FRZ	FREEZER	ME	MEASURE	PWR	POWER	THD	THREAD
		ADJ	ADJACENT, ADJOINING, OR ADJUSTABLE	CSK	COUNTER SUNK	FS	FASTENER	MEAS	MEASURE	QA	QUALITY ASSURANCE	THK	THICKNESS
H	<div>one quarter inch = one foot</div>	ADMIN	ADMINISTRATION	CSMT	CASEMENT	FT	FEET OR FOOT	MECH	MECHANICAL	OC	QUALITY CONTROL	THM	THERM
		ADB	AUTOMATIC DOOR BOTTOM	CSWK	CASEWORK	FTG	FOOTING	MECH RM	MEDICAL ROOM	OC	QUALITY CONTROL	THM	THERM
		AF	ABOVE FINISHED COUNTER	CT	CERAMIC TILE	URG	URGING	ME	MEDIUM	OC	QUALITY CONTROL	THM	THERM
I	<div>one quarter inch = one foot</div>	AFB	ABOVE FINISHED FLOOR	CTB	CERAMIC TILE BASE	FURN	FURNISH OR FURNITURE	MED	MEDIUM MEDICAL	OC	QUALITY CONTROL	THM	THERM
		AFG	ABOVE FINISHED GRADE	CT	CERAMIC TILE	FUT	FUTURE	MEK	METHYL ETHYL KETONE	OC	QUALITY CONTROL	THM	THERM
		AFS	ABOVE FINISHED SLAB	CTG	COATING	FUT	FUTURE	MEK	METHYL ETHYL KETONE	OC	QUALITY CONTROL	THM	THERM
J	<div>one quarter inch = one foot</div>	AGA	AMERICAN GAS ASSOCIATION	CTR	CENTER CONTOUR	FWC	FABRIC WALLCOVERING	MEMB	MEMBRANE	OC	QUALITY CONTROL	THM	THERM
		AGC	ASSOCIATED GENERAL CONTRACTORS	CTV	CABLE TELEVISION	GA	GAGE OR GYPSUM ASSOCIATION	MEMO	MEMORANDUM	OC	QUALITY CONTROL	THM	THERM
		AGS	AMERICAN INSTITUTE OF ARCHITECTS	CU	COPPER C	GAL	GALVANIC OR GALVANIZED	ME	MILL FINISH	OC	QUALITY CONTROL	THM	THERM
K	<div>one quarter inch = one foot</div>	AISC	AMERICAN INSTITUTE OF STEEL CONSTRUCTION	CU FT	CUBIC FEET	GALV STL	GALVANIZED STEEL	MFG	MANUFACTURING	OC	QUALITY CONTROL	THM	THERM
		ALT	ALTERNATE	CU YD	CUBIC YARD	GB	GENERAL CONTRACTOR	MAN	MANUFACTURE	OC	QUALITY CONTROL	THM	THERM
		ALT NO	ALTERNATE NUMBER	CURT	CURTAIN	GD	GUARD	MFR REC	MANUFACTURER'S RECOMMENDATION	OC	QUALITY CONTROL	THM	THERM
L	<div>one quarter inch = one foot</div>	ALUM	ALUMINUM	CYL	CYLINDER	GDR	GUARD RAIL	MGT	MANAGEMENT	OC	QUALITY CONTROL	THM	THERM
		AMP	AMPERE	CYL L	CYLINDER LOCK	GEN	GENERAL OR GENERATOR	MH	MANHOLE	OC	QUALITY CONTROL	THM	THERM
		AMT	AMOUNT	D	DEPTH OR PENNY (NAIL)	GFRG	GLASS-FIBER-REINFORCED CONCRETE	MIC	MICROPHONE	OC	QUALITY CONTROL	THM	THERM
M	<div>one quarter inch = one foot</div>	ANOD	ANODIZE	D	DEPTH OR PENNY (NAIL)	GFRG	GLASS-FIBER-REINFORCED CONCRETE	MID	MIDDLE	OC	QUALITY CONTROL	THM	THERM
		ANSI	AMERICAN NATIONAL STANDARDS INSTITUTE	CLASS D DOOR	CLASS D DOOR	GR	GLASS	MIN	MINIMUM	OC	QUALITY CONTROL	THM	THERM
		ANT	ANTENNA	DAT	DATUM	GL BLK	GLASS BLOCK	MIN	MINUTE	OC	QUALITY CONTROL	THM	THERM
N	<div>one quarter inch = one foot</div>	APA	AMERICAN PLYWOOD ASSOCIATION	DBL	DOUBLE	GLU LAM	GLUED LAMINATED WOOD	MISC	MISCELLANEOUS	OC	QUALITY CONTROL	THM	THERM
		APPD	APPROXIMATE	DBL GLZ	DOUBLE GLAZE	GR FL	GROUND FLOOR	MIT	MITER	OC	QUALITY CONTROL	THM	THERM
		APPROX	APPROXIMATE	DEGREE	DEGREE	GRAN	GRANITE	MKR	MARKER	OC	QUALITY CONTROL	THM	THERM
O	<div>one quarter inch = one foot</div>	APT	APARTMENT	DE	DELETE	GRTG	GRATING	ML	METAL LATH	OC	QUALITY CONTROL	THM	THERM
		ARCH	ARCHITECT	DEPT	DEPARTMENT	GSR	GYPSUM SHEATHING BOARD	MLDG	MOLDING (MOLDING)	OC	QUALITY CONTROL	THM	THERM
		ASB	ASBESTOS	DET	DETAIL	GSU	GLAZED STRUCTURAL UNIT	MLWK	MILLWORK	OC	QUALITY CONTROL	THM	THERM
P	<div>one quarter inch = one foot</div>	ASB	ASBESTOS	DET	DETAIL	GT	GROUT	MO	MASONRY OPENING OR MOTOR OPERATED	OC	QUALITY CONTROL	THM	THERM
		ASKLR	AMERICAN WOOD PRESERVERS' ASSOCIATION	DI	ELECTRIC WATER COOLER	GUAR	GUARANTEE	MOD	MODIFY OR MODULE	OC	QUALITY CONTROL	THM	THERM
		ASPH	ASPHALT	DIAG	DIAGONAL DIAGRAM	GUT	GUTTER	MOD BIT	MODIFIED BITUMEN	OC	QUALITY CONTROL	THM	THERM
Q	<div>one quarter inch = one foot</div>	ASSN	ASSOCIATION	DIAG	DIAGONAL DIAGRAM	QYP	GYPSUM	MON	MONITOR	OC	QUALITY CONTROL	THM	THERM
		ASSN	ASSOCIATION	DIAG	DIAGONAL DIAGRAM	GYP BD	GYPSUM BOARD	MOPR	MOP RACK	OC	QUALITY CONTROL	THM	THERM
		ASTM	AMERICAN SOCIETY FOR TESTING AND MATERIALS	DIFF	DIFFERENCE OR DIFFUSER	GYP PLAS	GYPSUM PLASTER	MR	MOISTURE RESISTANT	OC	QUALITY CONTROL	THM	THERM
R	<div>one quarter inch = one foot</div>	ATCH	ATTACHMENT	DIM	DIMENSION	H	HIGH	MTD	MOUNTED	OC	QUALITY CONTROL	THM	THERM
		ATM	AUTOMATIC TELLER MACHINE	DIP	DIRECTION	H PLAM	HIGH PRESSURE PLASTIC LAMINATE	MTG	MOUNTING	OC	QUALITY CONTROL	THM	THERM
		ATS	AUTOMATIC TRANSFER SWITCH	DIST	DISTANCE	HAZ MAT	HAZARDOUS MATERIALS	MTL	METAL	OC	QUALITY CONTROL	THM	THERM
S	<div>one quarter inch = one foot</div>	AUTO	AUTOMATIC	DIV	DIVIDE OR DIVISION	HB	HOSE BIBB	MULL	MULLION	OC	QUALITY CONTROL	THM	THERM
		AUX	AUXILIARY	DOC	DOCUMENT	HL	HOLLOW CORE	MW	MICROWAVE	OC	QUALITY CONTROL	THM	THERM
		AVE	AUDIO VISUAL	DOUG FIR	DOUGLAS FIR	HCWD	HOLLOW CORE WOOD DOOR	MWP	MEMBRANE WATERPROOFING	OC	QUALITY CONTROL	THM	THERM
T	<div>one quarter inch = one foot</div>	AV	AVENUE	DNR	DRAINAGE	HDBD	HARDBOARD	N	NORTH	OC	QUALITY CONTROL	THM	THERM
		AVG	AVERAGE	DNR	DRAINAGE	HDC	HIGH DENSITY OVERLAY	NA	NOT APPLICABLE	OC	QUALITY CONTROL	THM	THERM
		AW	ACID WASTE	DR	DOOR	HDR	HEADER	NAAMM	NATIONAL ASSOCIATION OF ARCHITECTURAL MANUFACTURERS	OC	QUALITY CONTROL	THM	THERM
U	<div>one quarter inch = one foot</div>	AWI	ARCHITECTURAL WOODWORKING INSTITUTE	DR CL	DOOR CLOSER	HDR	HEADER	NAT	NATIONAL	OC	QUALITY CONTROL	THM	THERM
		AWPA	AMERICAN WOOD PRESERVERS' ASSOCIATION	DR FR	DOOR FRAME	HDW	HARDWARE	NATL	NATIONAL	OC	QUALITY CONTROL	THM	THERM
		AWT	AMERICAN WELDING SOCIETY	DR OPNG	DOOR OPENING	HDWD	HARDWOOD	NC	NOISE CRITERIA	OC	QUALITY CONTROL	THM	THERM
V	<div>one quarter inch = one foot</div>	AWT	ACOUSTICAL WALL TREATMENT	DS	DOWNSPOUT	HEX	HEXAGON	NCMBL	NONCOMBUSTIBLE	OC	QUALITY CONTROL	THM	THERM
		B LABEL	CLASS B DOOR	DGN	DESIGN	HGR	HANGER	NEG	NEGATIVE	OC	QUALITY CONTROL	THM	THERM
		B PL	BASE PLATE	DWG	DRAWING	HMD	HOLLOW METAL DOOR	NEMA	NATIONAL ELECTRICAL MANUFACTURERS ASSOCIATION	OC	QUALITY CONTROL	THM	THERM
W	<div>one quarter inch = one foot</div>	BALC	BALCONY	DWTR	DUMBWATER	HMDP	HOLLOW METAL DOOR AND FRAME	NEUT	NEUTRAL	OC	QUALITY CONTROL	THM	THERM
		BAT	BATH	E	EAST	HMF	HOLLOW METAL FRAME	NFPA	NATIONAL FIRE CODE	OC	QUALITY CONTROL	THM	THERM
		BB	BULLETIN BOARD	E	EAST	HNDRL	HANDRAIL	NFPA	NATIONAL FIRE PROTECTION ASSOCIATION	OC	QUALITY CONTROL	THM	THERM
X	<div>one quarter inch = one foot</div>	BEV	BEVEL	E	EAST	HO	HOLD OPEN	NIC	NOT IN CONTRACT	OC	QUALITY CONTROL	THM	THERM
		BHMA	BUILDER'S HARDWARE MANUFACTURER'S ASSOCIATION	E	EAST	HOSP	HOSPITAL	NOM	NOMINAL	OC	QUALITY CONTROL	THM	THERM
		BITUM	BITUMINOUS	E	EAST	HP	HIGH PRESSURE OR HORSEPOWER	NR	NOISE REDUCTION	OC	QUALITY CONTROL	THM	THERM
Y	<div>one quarter inch = one foot</div>	BKG	BULKHEAD	E	EAST	HQ	HEAT STRENGTHENED (GLASS) OR HIGH STRENGTH	NRCA	NATIONAL ROOFING CONTRACTORS ASSOCIATION	OC	QUALITY CONTROL	THM	THERM
		BLD	BUILD	E	EAST	HSE	HOUSE	NRP	NONREMOVABLE	OC	QUALITY CONTROL	THM	THERM
		BLDG	BUILDING	E	EAST	HSPKPG	HOLDSKEEPING	NUM	NUMERAL	OC	QUALITY CONTROL	THM	THERM
Z	<div>one quarter inch = one foot</div>	BLVD	BULEVARD	E	EAST	HST	HOIST	O/O	OUT TO OUT	OC	QUALITY CONTROL	THM	THERM
		BM	BEAM OR BENCHMARK	E	EAST	HT	HEIGHT	O	OXYGEN	OC	QUALITY CONTROL	THM	THERM
		BOT	BOTTOM	E	EAST	HT	HEIGHT	OA	OUTSIDE AIR OR OVERALL	OC	QUALITY CONTROL	THM	THERM

BUILDING IS FULLY SPRINKLERED

Revisions:		Date:	
CONSULTANTS:		ARCHITECT/ENGINEERS:	
COX DESIGN ASSOCIATES		ARCHITECTURE PLANNING INTERIORS	
Austin 5121 Bee Caves Road, Suite 203 Austin, Texas 78746 T:512 - 327 - 4149 F:512 - 327 - 7679 coxdesign@austin.rr.com		Chicago 345 N. Canal St. Suite 701 Chicago, IL 60605 T:312 - 698 - 3880 F:312 - 454 - 9439 cbcoo@coxtd.com	
Approved: Assistant Director		Approved: Chief of Staff	
Approved: Service Chief		Approved: Service Chief	
Approved: Chief, Bio-Med		Approved: Chief, EMS	
Approved: Chief, IT		Approved: Chief, M&O	
Approved: Chief, Safety		Approved: Chief	
Approved: Chief, Engineering		Approved: Service Chief	
Approved: Chief, Infection Control		Approved: Chief, Police	
Approved: Chief, Fire		Approved: Chief	
Drawing Title		Project Name	
ARCHITECTURAL ABBREVIATIONS		REPLACE SURGICAL FLOORING	
Location		Project Number	
CAPTAIN JAMES A. LOVELL FHCC 3001 GREEN BAY ROAD NORTH CHICAGO, IL 60064		556-13-106	
Building Number		Checked	
133-2C		RHC	
Drawn		RAT	
Dwg. of		Drawing Number	
		133-AI-001	
		Date	
		AUGUST 7, 2013	
		Office of Construction and Facilities Management	
		Department of Veterans Affairs	

A

B

C

D

E

F

16

0

three inches = one foot

one and one half inches = one foot

one inch = one foot


three quarters inch = one foot

one half inch = one foot

three eighths inch = one foot

one quarter inch = one foot

one eighth inch = one foot

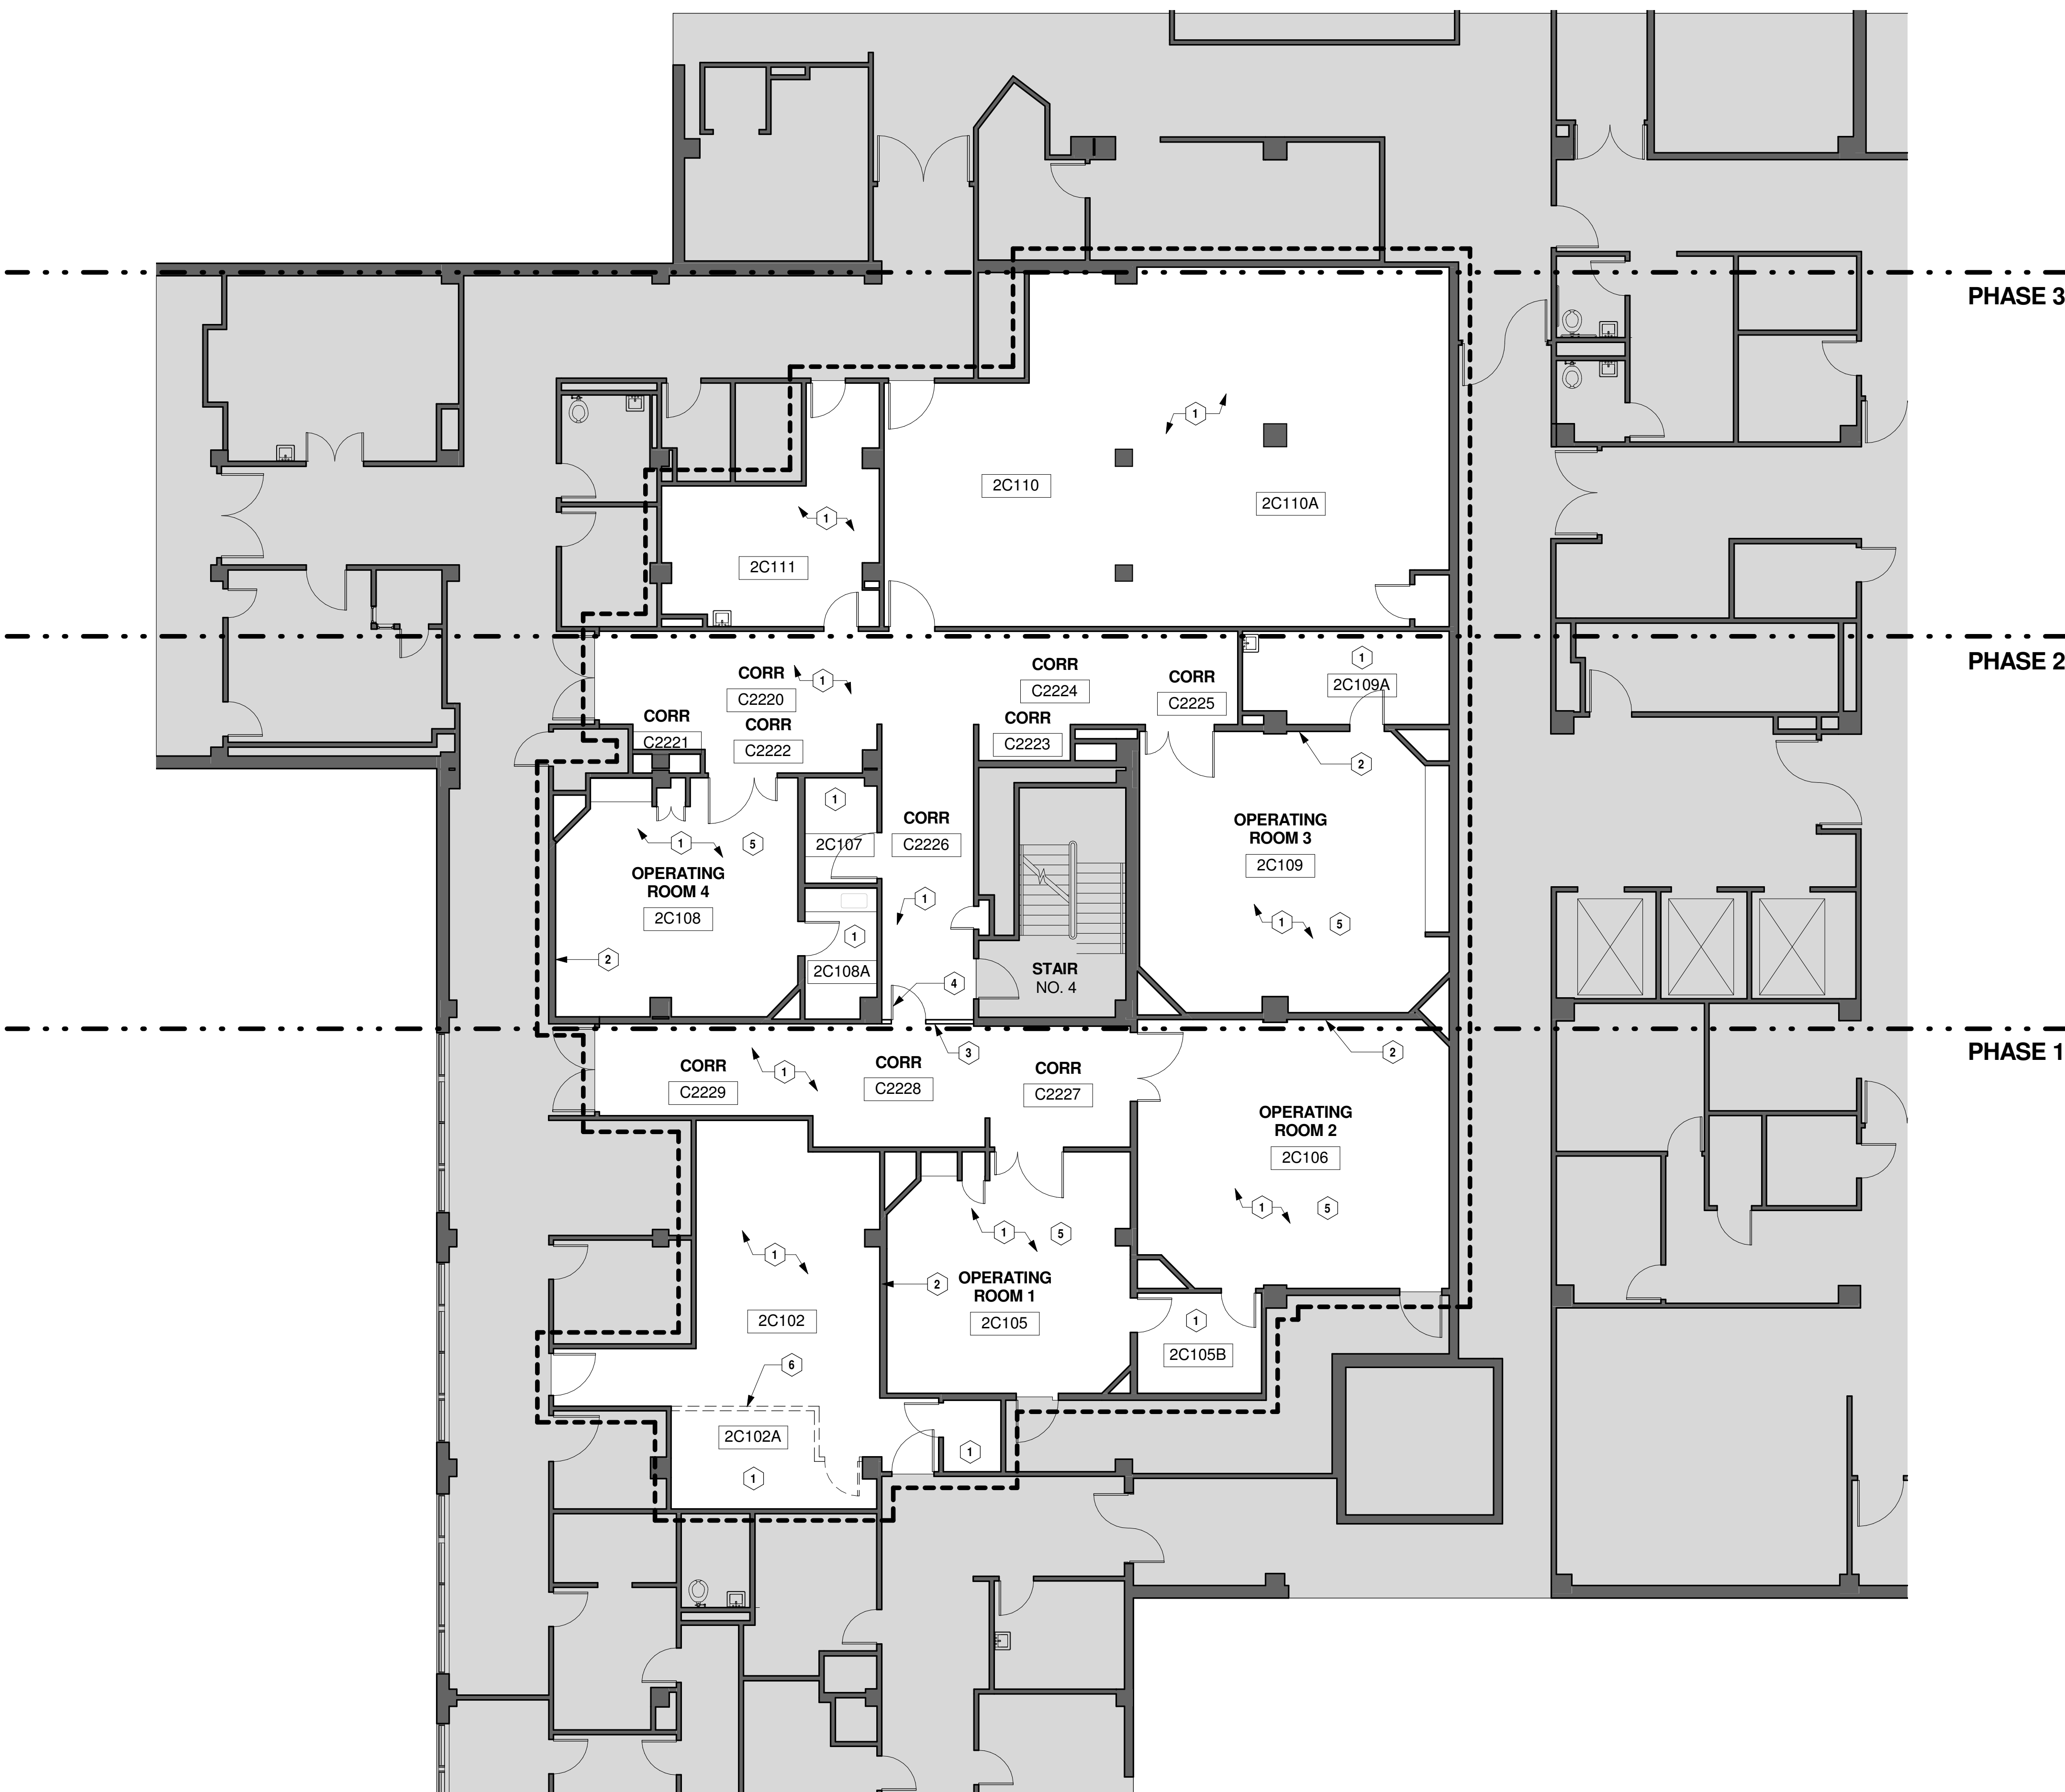

1 2ND FLOOR - DEMOLITION PLAN
SCALE: 1/8" = 1'-0"

GRAPHIC LEGEND

AREA IN CONTRACT

DASHED LINE DENOTES ITEM TO BE DEMOLISHED

EXISTING WALLS TO BE REMOVED

EXISTING DOOR TO BE REMOVED

DEMOLITION PLAN NOTE

AREA NOT IN CONTRACT

LINE DENOTES ITEM TO REMAIN

EXISTING WALLS TO REMAIN

EXISTING DOOR TO REMAIN

LIMITS OF CONSTRUCTION

PHASING

- GENERAL NOTES
1. VERIFY ALL DIMENSIONS AND CONDITIONS AT JOB SITE. PORTIONS OF EXISTING CONSTRUCTION MAY HAVE BEEN REMOVED BY OWNER.

2. REMOVE FLOOR FINISHES, AND MASTIC INCLUDING SETTING BED IN CERAMIC TILE AREAS IF APPLICABLE, WHERE NEW FLOORING IS INDICATED IN ROOM FINISH SCHEDULE.

3. REMOVE ALL INTERIOR AND WALL MOUNTED ITEMS IN AREAS TO BE REMODELED. (REFER TO ROOM FINISH SCHEDULE) INCLUDING BUT NOT LIMITED TO, CABINETRY, EQUIPMENT, LOCKERS, TOILET PARTITIONS, SHELVING HOOKSTRIPS, HANDRAILS, CLOSET POLES, CHALK AND TACK BOARDS, MIRRORS, WALL AND CEILING TRIM, BASE.

4. REMOVE EXISTING WALL FINISHES IN ROOMS WHERE NEW FINISHES ARE INDICATED IN THE ROOM FINISH SCHEDULE. EXISTING WALLS TO BE PREPARED AS REQUIRED TO ACCEPT NEW SCHEDULED FINISHES.

5. ALL EXISTING WALL SURFACES IN OPERATING ROOMS ARE TO BE PREPARED FOR INSTALLATION OF NEW TERRAZZO TILE.

6. REFER TO PLUMBING HVAC AND ELECTRICAL PLANS FOR ADDITIONAL DEMOLITION ITEMS AND NOTES. COORDINATE WORK WITH PLUMBING, HVAC AND ELECTRICAL REQUIREMENTS.

7. MAINTAIN CONTINUOUS UTILITY SERVICE TO ALL SPACES IN THE BUILDING NOT AFFECTED BY THIS WORK. COORDINATE WITH OWNER ANY DISRUPTION IN SERIES REQUIRED TO PERFORM WORK OR TO MODIFY EXISTING PIPING, DUCTWORK, OR ANY ASSOCIATED EQUIPMENT.

8. WORK SHALL BE PERFORMED DURING THE FOLLOWING HOURS:
MONDAY THROUGH THURSDAY - 1800 TO 0500 EACH DAY
WEEKENDS - FRIDAY 1800 TO MONDAY 0500

9. FHCC ACCESS TO, AND USE OF, OPERATING ROOMS NOT UNDER CONSTRUCTION MUST BE MAINTAINED AT ALL TIMES. SEE DETAIL 6/AS-501 FOR TEMPORARY CONSTRUCTION WALL.

- SHEET NOTES
- A ALL EXISTING FLOOR FINISH MATERIALS, WALL BASE, AND WAINSCOT MATERIALS ARE TO BE REMOVED AND ALL FLOOR SURFACES TO BE PREPARED FOR INSTALLATION OF NEW FLOOR FINISH.

B PREPARATION OF CONCRETE SUBFLOOR SURFACE IS TO BE INSPECTED BY CONTRACTOR FOR COMPLIANCE WITH THE INTENT OF THE CONTRACT DOCUMENTS. CONTRACTOR IS TO PROVIDE TO C.O.R. WRITTEN CONFIRMATION THE CONTRACTOR AND FLOORING MANUFACTURER'S CONCURRENCE THE SUBSTRATE IS PROPERLY PREPARED FOR INSTALLATION OF THE FINISH FLOORING.

C EXISTING DOORS AND FRAMES TO REMAIN. SEE DETAIL 5/AS-501.

D EXISTING CASEWORK TO REMAIN.

E CONSTRUCT A DUST-PROOF PARTITION TO SEPARATE AREAS OF CONSTRUCTION FROM ADJACENT OCCUPIED AREAS OUTSIDE SCOPE OF CONSTRUCTION. SEE DETAIL 6/AS-501.

F PRIOR TO START OF WORK, SEAL ALL HVAC GRILLES AND DIFFUSERS FOR DURATION OF WORK. COORDINATE WITH FHCC.

- KEY NOTES
- 1 REMOVE EXISTING FLOORING, BASE, AND COVE AND PREPARE SLAB FOR NEW FLOORING FINISH.

2 PREP AND REPAIR WALLS FOR WAINSCOT.

3 TEMPORARY CONSTRUCTION PHASING SEPARATION. REFER TO DETAIL 6/AS-501.

4 PROVIDE LOCKABLE DOOR AND FRAME WITH CLOSER AT TEMPORARY CONSTRUCTION PHASING SEPARATION. CONTRACTOR TO PROVIDE KEYS TO COR.


5 ALL MEDICAL EQUIPMENT TO BE WRAPPED AND SEALED PER COR APPROVAL.

6 WALL AND DOOR TO BE REMOVED BY FHCC AT START OF PHASE 1 WORK.


KEY PLAN

BUILDING IS
FULLY
SPRINKLERED


Revisions:		Date:		CONSULTANTS:		ARCHITECT/ENGINEERS:		Approved: Assistant Director	Approved: Chief of Staff	Approved: Chief, Engineering	Drawing Title DEMOLITION PLAN	Project Name REPLACE SURGICAL FLOORING		Project Number 556-13-106		Date AUGUST 7, 2013		Drawing Number 133-AD-101		Building Number 133-2C		Checked RHC	Drawn RAT	Dwg. of	Office of Construction and Facilities Management Department of Veterans Affairs	
								Approved: Service Chief	Approved: Service Chief	Approved: Service Chief																
								Approved: Chief, Bio-Med	Approved: Chief, EMS	Approved: Chief, Infection Control																
								Approved: Chief, IT	Approved: Chief, M&O	Approved: Chief, Police																
								Approved: Chief, Safety	Approved: Chief	Approved: Chief																

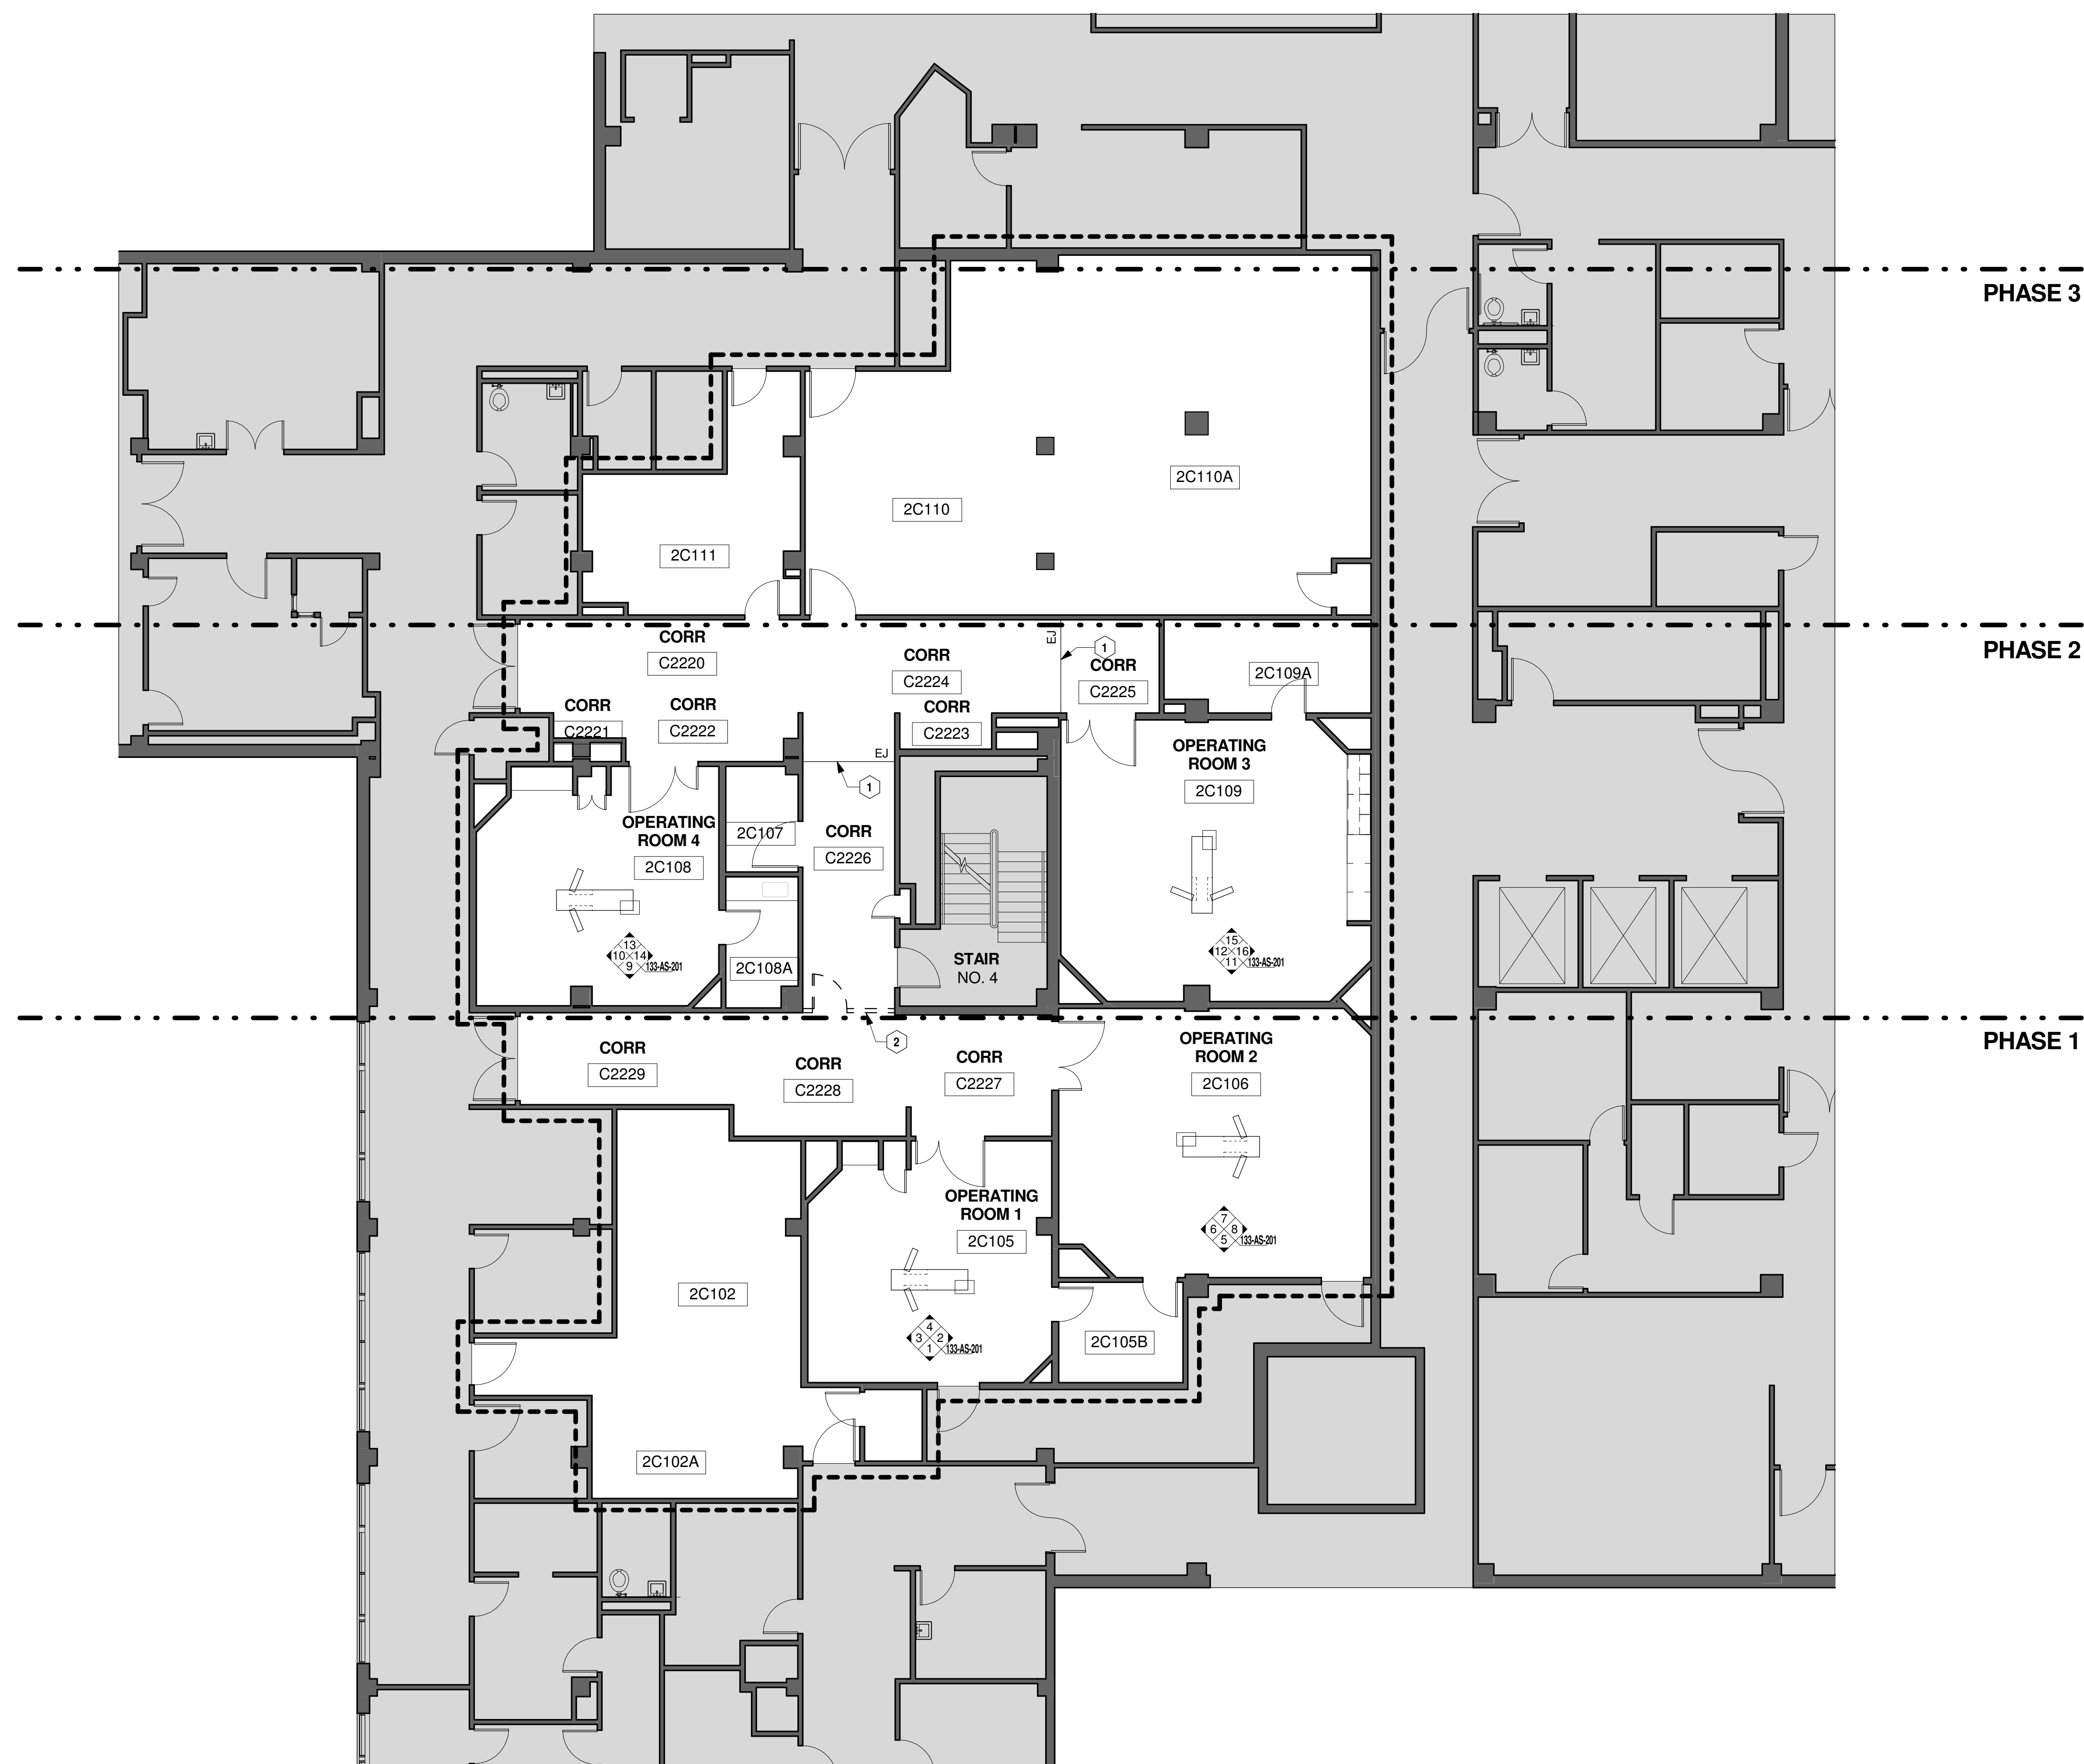

GRAPHIC LEGEND

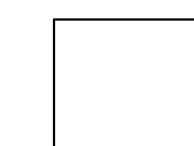

AREA IN CONTRACT

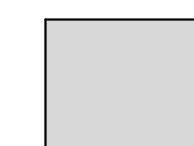

AREA NOT IN CONTRACT




CONSTRUCTION LIMITS



PHASING



EXISTING WALL TO REMAIN

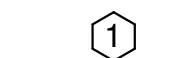

FLOOR PLAN NOTE

GENERAL NOTES

1. VERIFY ALL DIMENSIONS AND CONDITIONS AT JOB SITE.
2. UNLESS NOTED TO BE REMOVED AND DISPOSED, ALL EXISTING ITEMS ARE TO REMAIN. THEY SHALL BE PROTECTED FROM DAMAGE DUE TO CONSTRUCTION ACTIVITIES. ANY EXISTING ITEMS TO REMAIN THAT BECOME DAMAGED DUE TO CONSTRUCTION ACTIVITIES SHALL BE REPAIRED OR REPLACED TO MATCH EXISTING AT NO ADDITIONAL COST TO THE OWNER..
3. MAINTAIN CONTINUOUS UTILITY SERVICE TO ALL SPACES IN THE BUILDING NOT AFFECTED BY THIS WORK. COORDINATE WITH OWNER ANY DISRUPTION IN SERVICES REQUIRED TO PERFORM WORK OR TO MODIFY EXISTING PIPING, DUCTWORK, OR ANY ASSOCIATED EQUIPMENT.
4. THE GENERAL CONTRACTOR SHALL REPORT ANY UNFORESEEN FIELD CONDITIONS, ERRORS, INCONSISTENCIES, OR OMISSIONS DISCOVERED AT ANY TIME DURING THE WORK. UPON SUCH DISCOVERY, THE CONTRACTOR SHALL IMMEDIATELY CONTACT THE C.O.R. FOR CLARIFICATION BEFORE PROCEEDING OR CONTINUING WITH THAT PORTION OF THE WORK OR ANY PORTION RELATED THERE TO.
5. ALL WORK SHALL CONFORM TO ALL APPLICABLE CODES AND STANDARDS INCLUDING THE INTERNATIONAL BUILDING CODE 2012 EDITION, VA MASTER SPECIFICATIONS, AND NFPA 101 2012 EDITION.
6. CONTRACTOR SHALL NOT BARRICADE / BARRIER EMERGENCY EGRESS TO OR FROM THIS AREA. CONTRACTOR SHALL MAINTAIN EXIT TO EXTERIOR DURING THE WORK PROCESS
7. PROVIDE ACCESS TO THE WORK AS DIRECTED BY THE C.O.R. SECURE ACCESS POINT AS SPECIFIED AND DIRECTED BY THE COR. PROVIDE WALK-OFF MATS TO MEET FACILITY INFECTION CONTROL GUIDELINES AT EACH ACCESS POINT.
8. SHADED AREAS ARE GENERALLY OUT OF SCOPE FOR THIS PROJECT.
9. NOTATIONS FOR ITEMS OF WORK APPLY TO EACH AND EVERY GRAPHICAL INDICATION SHOWN ON THE DRAWINGS, WHETHER OR NOT NOTED.
10. THE GENERAL CONTRACTOR SHALL VISIT THE SITE, VERIFY FIELD CONDITIONS AND CAREFULLY COMPARE SUCH FIELD CONDITIONS AND OTHER INFORMATION KNOWN TO THE CONTRACTOR WITH CONTRACT DOCUMENTS.
11. THE GENERAL CONTRACTOR SHALL REPORT ANY UNFORESEEN FIELD CONDITIONS, ERRORS, INCONSISTENCIES, OR OMISSIONS DISCOVERED AT ANY TIME DURING THE WORK. UPON SUCH DISCOVERY, THE CONTRACTOR SHALL IMMEDIATELY CONTACT THE ARCHITECT AND COR FOR CLARIFICATION BEFORE PROCEEDING OR CONTINUING WITH THAT PORTION OF THE WORK OR ANY PORTION RELATED THERE TO.
12. THE GENERAL CONTRACTOR SHALL NOTIFY THE COR AND THE ARCHITECT OF ANY DISCREPANCIES BETWEEN THE DRAWINGS, NOTES AND ACTUAL FIELD CONDITIONS BEFORE BIDDING AND COMMENCING ANY WORK, AND REQUEST CLARIFICATION IN WRITING.
13. WORK SHALL BE PERFORMED DURING THE FOLLOWING HOURS:
MONDAY THROUGH THURSDAY - 1800 TO 0500 EACH DAY
WEEKENDS - FRIDAY 1800 TO MONDAY 0500
14. FHCC ACCESS TO, AND USE OF, OPERATING ROOMS NOT UNDER CONSTRUCTION MUST BE MAINTAINED AT ALL TIMES. SEE DETAIL 6/A5-501 FOR TEMPORARY CONSTRUCTION WALL.


SHEET NOTES

- A. DIMENSIONS ON FLOOR PLAN ARE BASED ON FACE OF FINISHED WALL TO FACE OF FINISHED WALL (NOMINAL)
- B. VERIFY ALL DIMENSIONS AND CONDITIONS AT JOB SITE.
- C. REFER TO SHEET 1-AS601 FOR ROOM FINISH SCHEDULE AND NOTES.
- D. WALLS AND CEILINGS TO BE PAINTED BY OWNER.
- E. ALL EXISTING WALL MOUNTED ITEMS AND DEVICES PENETRATING THE WALL OR MOUNTED ON THE WALL SURFACE ARE TO BE PROPERLY SECURED AND MOUNTED FOR THE INSTALLATION OF NEW TERRAZZO TILE.

KEY NOTES

FLOOR PLAN KEYED NOTES

- ① EXPANSION JOINT. SEE DETAIL 3/AS-501.
- ② TEMPORARY CONSTRUCTION PHASING SEPARATION TO BE REMOVED AT THE COMPLETION OF CONSTRUCTION.

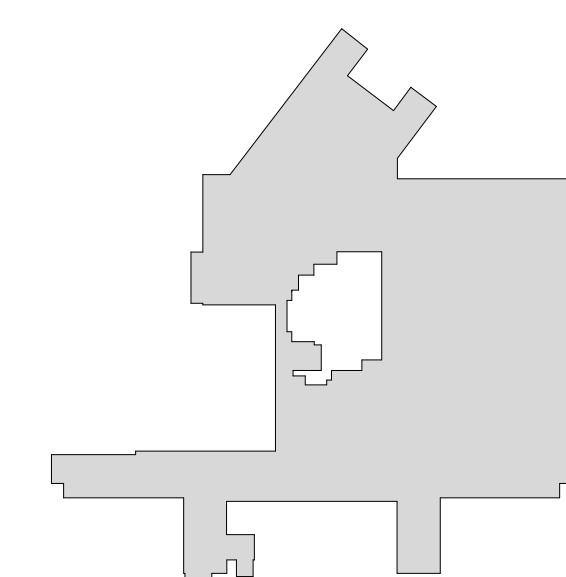



KEY PLAN

**BUILDING IS
FULLY
SPRINKLERED**

1 2ND FLOOR PLAN
SCALE: 1/8" = 1'-0"

SCALE: 1/8" = 1'-0"

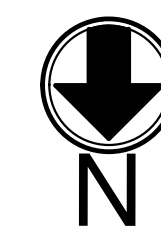[illegible]

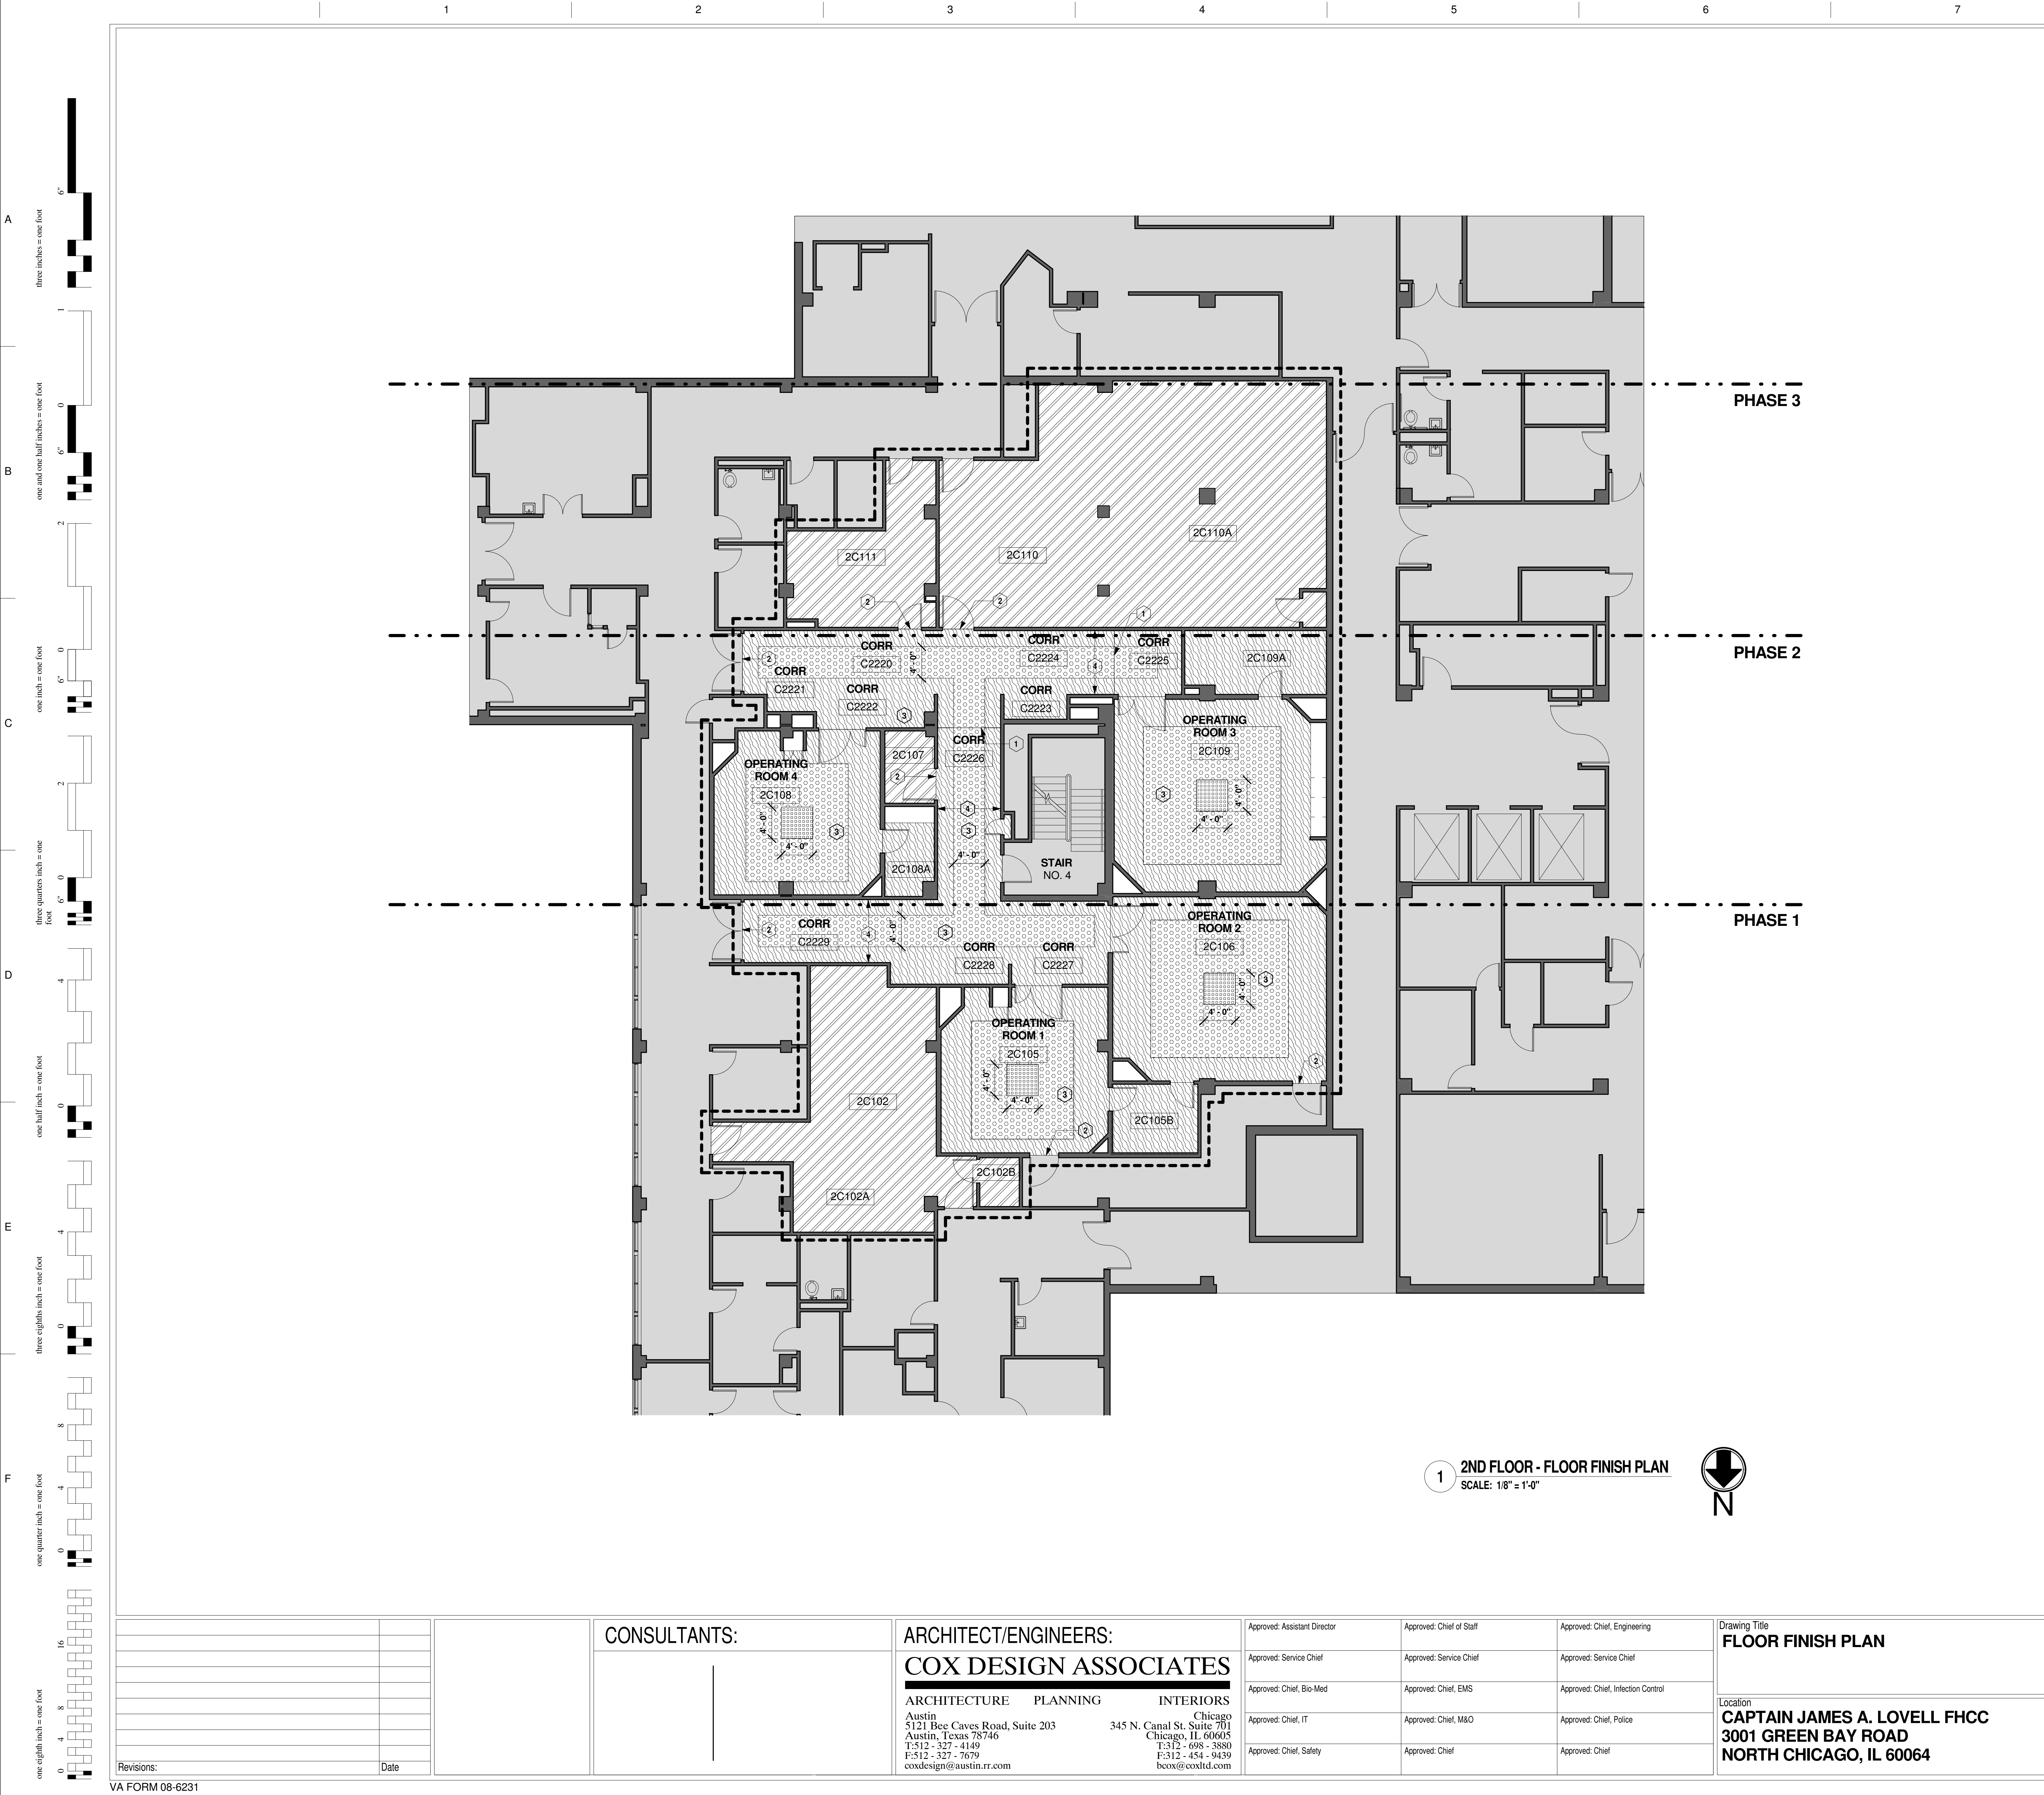

GRAPHIC LEGEND

AREA IN CONTRACT

AREA NOT IN CONTRACT

CONSTRUCTION LIMITS

EXISTING WALL TO REMAIN

PHASING

FLOOR PLAN NOTE

FLOOR TILE

FT-1

FT-2

FT-3

SV-1

GENERAL NOTES

1. VERIFY ALL DIMENSIONS AND CONDITIONS AY JOB SITE.

2. UNLESS NOTED TO BE REMOVED AND DISPOSED, ALL EXISTING ITEMS ARE TO REMAIN. THEY SHALL BE PROTECTED FROM DAMAGE DUE TO CONSTRUCTION ACTIVITIES. ANY EXISTING ITEMS TO REMAIN THAT BECOME DAMAGED DUE TO CONSTRUCTION ACTIVITIES SHALL BE REPAIRED OR REPLACED TO MATCH EXISTING AT NO ADDITIONAL COST TO THE OWNER..

3. MAINTAIN CONTINUOUS UTILITY SERVICE TO ALL SPACES IN THE BUILDING NOT AFFECTED BY THIS WORK. COORDINATE WITH OWNER ANY DISRUPTION IN SERVICES REQUIRED TO PERFORM WORK OR TO MODIFY EXISTING PIPING, DUCTWORK, OR ANY ASSOCIATED EQUIPMENT.

4. THE GENERAL CONTRACTOR SHALL REPORT ANY UNFORESEEN FIELD CONDITIONS, ERRORS, INCONSISTENCIES, OR OMISSIONS DISCOVERED AT ANY TIME DURING THE WORK, UPON SUCH DISCOVERY, THE CONTRACTOR SHALL IMMEDIATELY CONTACT THE C.O.R. FOR CLARIFICATION BEFORE PROCEEDING OR CONTINUING WITH THAT PORTION OF THE WORK OR ANY PORTION RELATED THERE TO.

5. ALL WORK SHALL CONFORM TO ALL APPLICABLE CODES AND STANDARDS INCLUDING THE INTERNATIONAL BUILDING CODE 2012 EDITION, VA MASTER SPECIFICATIONS, AND NFPA 101 2012 EDITION.

6. CONTRACTOR SHALL NOT BARRICADE / BARRIER EMERGENCY EGRESS TO OR FROM THIS AREA. CONTRACTOR SHALL MAINTAIN EXIT TO EXTERIOR DURING THE WORK PROCESS

7. PROVIDE ACCESS TO THE WORK AS DIRECTED BY THE C.O.R. SECURE ACCESS POINT AS SPECIFIED AND DIRECTED BY THE COR. PROVIDE WALK-OFF MATS TO MEET FACILITY INFECTION CONTROL GUIDELINES AT EACH ACCESS POINT.

8. SHADED AREAS ARE GENERALLY OUT OF SCOPE FOR THIS PROJECT.

9. NOTATIONS FOR ITEMS OF WORK APPLY TO EACH AND EVERY GRAPHICAL INDICATION SHOWN ON THE DRAWINGS, WETHER OR NOT NOTED.

10. THE GENERAL CONTRACTOR SHALL VISIT THE SITE, VERIFY FIELD CONDITIONS AND CAREFULLY COMPARE SUCH FIELD CONDITIONS AND OTHER INFORMATION KNOWN TO THE CONTRACTOR WITH CONTRACT DOCUMENTS.

11. THE GENERAL CONTRACTOR SHALL REPORT ANY UNFORESEEN FIELD CONDITIONS, ERRORS, INCONSISTENCIES, OR COMMISSIONS DISCOVERED AT ANY TIME DURING THE WORK, UPON SUCH DISCOVERY, THE CONTRACTOR SHALL IMMEDIATELY CONTRACT THE ARCHITECT AND COR FOR CLARIFICATION BEFORE PROCEEDING OR CONTINUING WITH THAT PORTION OF THE WORK OR ANY PORTION RELATED THERE TO.

12. THE GENERAL CONTRACTOR SHALL NOTIFY THE COR AND THE ARCHITECT OF ANY DISCREPANCIES BETWEEN THE DRAWINGS, NOTES AND ACTUAL FIELD CONDITIONS BEFORE BIDDING AND COMMENCING ANY WORK, AND REQUEST CLARIFICATION IN WRITING.

13. WORK SHALL BE PERFORMED DURING THE FOLLOWING HOURS:
MONDAY THROUGH THURSDAY - 1800 TO 0500 EACH DAY
WEEKENDS - FRIDAY 1800 TO MONDAY 0500

14. FHCC ACCESS TO, AND USE OF, OPERATING ROOMS NOT UNDER CONSTRUCTION MUST BE MAINTAINED AT ALL TIMES. SEE DETAIL 6/AS-501 FOR TEMPORARY CONSTRUCTION WALL.

SHEET NOTES

A CONTRACTOR SHALL REMOVE EXISTING FLOORING MATERIALS ENTIRELY AND PREPARE CONCRETE FLOORS FOR FLOORING MANUFACTURER'S ACCEPTANCE AND AS SPECIFIED FOR INSTALLATION OF NEW FLOORING MATERIALS AS SCHEDULED.

B CONTRACTOR SHALL LEVEL THE EXISTING CONCRETE FLOOR SURFACE IN ACCORDANCE WITH FLOORING MANUFACTURER'S RECOMMENDATIONS.

C CONTRACTOR SHALL INSTALL NEW FLOORING IN PATTERNS INDICATED TO THE GREATEST EXTENT POSSIBLE. PATTERN DEVIATIONS SHALL BE APPROVED BY THE C.O.R. PRIOR TO INSTALLATION.

D TERMINATE OR TRANSITION DISSIMILAR FLOORING MATERIALS AT THE CENTERLINE OF DOORS.

E PROVIDE A FLUSH TRANSITION BETWEEN FLOORING MATERIALS OF VARYING HEIGHTS. PROVIDE TRANSITION STRIPS AS INDICATED ON MATERIAL SCHEDULE.

F DIFFERENT FLOOR MATERIALS ADJACENT TO EACH OTHER ARE TO BE FLUSH. FEATHER AND ALIGN AS REQUIRED.

G TRANSITION STRIPS TO BE PROVIDED AT JOINT OF DIFFERING MATERIALS.

H LOCATE ALL FLOORING TRANSITIONS UNDER DOORS.

KEY NOTES

1 EXPANSION JOINT. SEE DETAIL 3/AS-501

2 TRANSITION STRIP AT DOOR THRESHOLD. SEE DETAIL 2/AS-501

3 CONTRACTOR TO PROVIDE SHOP DRAWINGS OF FLOOR TILE LAYOUT. UNO, COORDINATE POSITION AND DIMENSIONS OF FLOOR TILE AREAS WITH C.O.R.

4 DEDUCTIVE ALTERNATE No.1 - ELIMINATE TERRAZZO TILE WAINSCOT AT CORRIDORS. SEE DETAIL 9/AS-501 FOR COVE BASE DETAIL.

KEY PLAN

BUILDING IS FULLY SPRINKLERED

Project Name REPLACE SURGICAL FLOORING		Project Number 556-13-106		Office of Construction and Facilities Management	
Date AUGUST 7, 2013		Drawing Number 133-AS-102			
Building Number 133-2C		Checked RHC	Drawn RAT	Dwg. of	

Approved: Assistant Director

Approved: Chief of Staff

Approved: Chief, Engineering

Approved: Service Chief

Approved: Service Chief

Approved: Service Chief

Approved: Chief, Bio-Med

Approved: Chief, EMS

Approved: Chief, Infection Control

Approved: Chief, IT

Approved: Chief, M&O

Approved: Chief, Police

Approved: Chief, Safety


Approved: Chief

Approved: Chief


Drawing Title
FLOOR FINISH PLAN

Location
**CAPTAIN JAMES A. LOVELL FHCC
3001 GREEN BAY ROAD
NORTH CHICAGO, IL 60064**

A
three inches = one foot
B
one and one half inches = one foot
C
one inch = one foot
D
three quarters inch = one foot
E
one half inch = one foot
F
three eighths inch = one foot
one quarter inch = one foot
one eighth inch = one foot

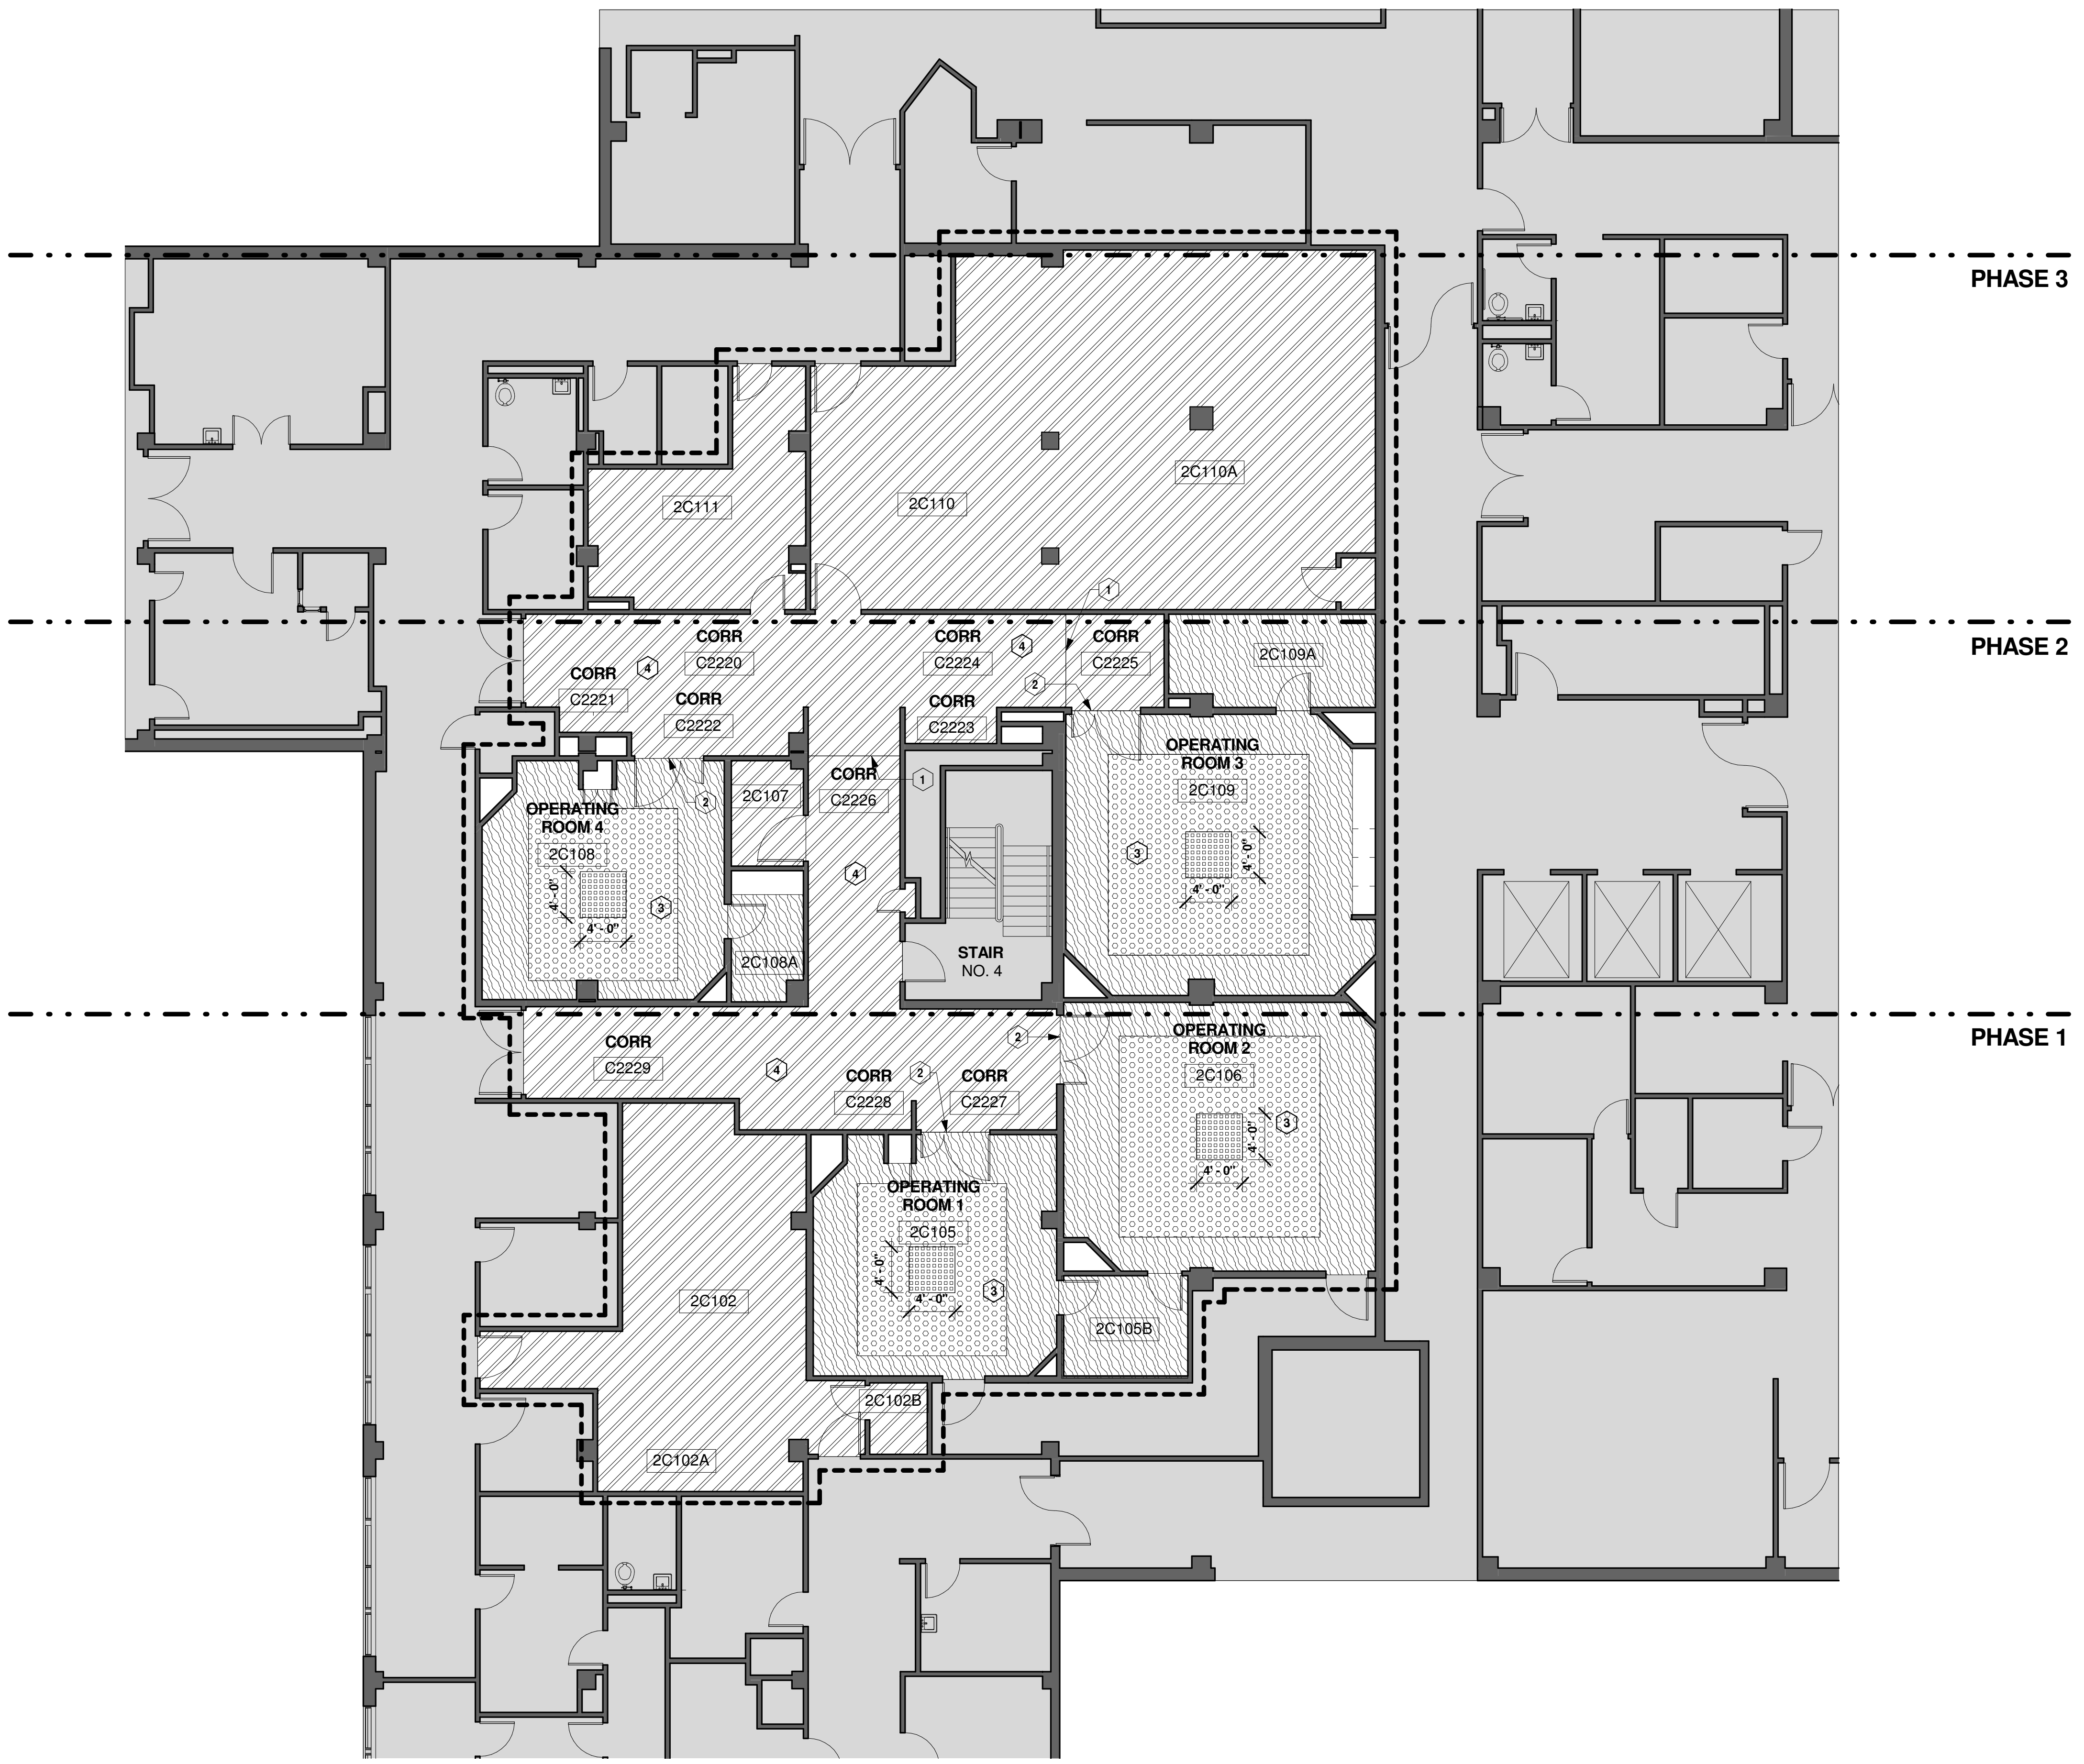

1 FLOOR FINISH PLAN - DEDUCTIVE ALTERNATE NO. 2
SCALE: 1/8" = 1'-0"

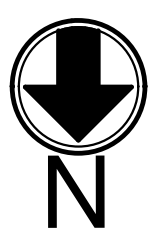

GRAPHIC LEGEND

AREA IN CONTRACT

AREA NOT IN CONTRACT

CONSTRUCTION LIMITS

EXISTING WALL TO REMAIN

PHASING

FLOOR PLAN NOTE

FLOOR TILE

FT-1

FT-2

FT-3

SV-1

GENERAL NOTES

- VERIFY ALL DIMENSIONS AND CONDITIONS AY JOB SITE.
- UNLESS NOTED TO BE REMOVED AND DISPOSED, ALL EXISTING ITEMS ARE TO REMAIN. THEY SHALL BE PROTECTED FROM DAMAGE DUE TO CONSTRUCTION ACTIVITIES. ANY EXISTING ITEMS TO REMAIN THAT BECOME DAMAGED DUE TO CONSTRUCTION ACTIVITIES SHALL BE REPAIRED OR REPLACED TO MATCH EXISTING AT NO ADDITIONAL COST TO THE OWNER.
- MAINTAIN CONTINUOUS UTILITY SERVICE TO ALL SPACES IN THE BUILDING NOT AFFECTED BY THIS WORK. COORDINATE WITH OWNER ANY DISRUPTION IN SERVICES REQUIRED TO PERFORM WORK OR TO MODIFY EXISTING PIPING, DUCTWORK, OR ANY ASSOCIATED EQUIPMENT.
- THE GENERAL CONTRACTOR SHALL REPORT ANY UNFORESEEN FIELD CONDITIONS, ERRORS, INCONSISTENCIES, OR OMISSIONS DISCOVERED AT ANY TIME DURING THE WORK, UPON SUCH DISCOVERY, THE CONTRACTOR SHALL IMMEDIATELY CONTACT THE C.O.R. FOR CLARIFICATION BEFORE PROCEEDING OR CONTINUING WITH THAT PORTION OF THE WORK OR ANY PORTION RELATED THERE TO.
- ALL WORK SHALL CONFORM TO ALL APPLICABLE CODES AND STANDARDS INCLUDING THE INTERNATIONAL BUILDING CODE 2012 EDITION, VA MASTER SPECIFICATIONS, AND NFPA 101 2012 EDITION.
- CONTRACTOR SHALL NOT BARRICADE / BARRIER EMERGENCY EGRESS TO OR FROM THIS AREA. CONTRACTOR SHALL MAINTAIN EXIT TO EXTERIOR DURING THE WORK PROCESS
- PROVIDE ACCESS TO THE WORK AS DIRECTED BY THE C.O.R. SECURE ACCESS POINT AS SPECIFIED AND DIRECTED BY THE COR. PROVIDE WALK-OFF MATS TO MEET FACILITY INFECTION CONTROL GUIDELINES AT EACH ACCESS POINT.
- SHADED AREAS ARE GENERALLY OUT OF SCOPE FOR THIS PROJECT.
- NOTATIONS FOR ITEMS OF WORK APPLY TO EACH AND EVERY GRAPHICAL INDICATION SHOWN ON THE DRAWINGS, WETHER OR NOT NOTED.
- THE GENERAL CONTRACTOR SHALL VISIT THE SITE. VERIFY FIELD CONDITIONS AND CAREFULLY COMPARE SUCH FIELD CONDITIONS AND OTHER INFORMATION KNOWN TO THE CONTRACTOR WITH CONTRACT DOCUMENTS.
- THE GENERAL CONTRACTOR SHALL REPORT ANY UNFORESEEN FIELD CONDITIONS, ERRORS, INCONSISTENCIES, OR COMMISSIONS DISCOVERED AT ANY TIME DURING THE WORK, UPON SUCH DISCOVERY, THE CONTRACTOR SHALL IMMEDIATELY CONTRACT THE ARCHITECT AND COR FOR CLARIFICATION BEFORE PROCEEDING OR CONTINUING WITH THAT PORTION OF THE WORK OR ANY PORTION RELATED THERE TO.
- THE GENERAL CONTRACTOR SHALL NOTIFY THE COR AND THE ARCHITECT OF ANY DISCREPANCIES BETWEEN THE DRAWINGS, NOTES AND ACTUAL FIELD CONDITIONS BEFORE BIDDING AND COMMENCING ANY WORK, AND REQUEST CLARIFICATION IN WRITING.
- WORK SHALL BE PERFORMED DURING THE FOLLOWING HOURS:
MONDAY THROUGH THURSDAY - 1800 TO 0500 EACH DAY
WEEKENDS - FRIDAY 1800 TO MONDAY 0500
- FHCC ACCESS TO, AND USE OF, OPERATING ROOMS NOT UNDER CONSTRUCTION MUST BE MAINTAINED AT ALL TIMES. SEE DETAIL 6/AS-501 FOR TEMPORARY CONSTRUCTION WALL.

SHEET NOTES

A

CONTRACTOR SHALL REMOVE EXISTING FLOORING MATERIALS ENTIRELY AND PREPARE CONCRETE FLOORS FOR FLOORING MANUFACTURER'S ACCEPTANCE AND AS SPECIFIED FOR INSTALLATION OF NEW FLOORING MATERIALS AS SCHEDULED.

B

CONTRACTOR SHALL LEVEL THE EXISTING CONCRETE FLOOR SURFACE IN ACCORDANCE WITH FLOORING MANUFACTURER'S RECOMMENDATIONS.

C

CONTRACTOR SHALL INSTALL NEW FLOORING IN PATTERNS INDICATED TO THE GREATEST EXTENT POSSIBLE. PATTERN DEVIATIONS SHALL BE APPROVED BY THE C.O.R. PRIOR TO INSTALLATION.

D

TERMINATE OR TRANSITION DISSIMILAR FLOORING MATERIALS AT THE CENTERLINE OF DOORS.

E

PROVIDE A FLUSH TRANSITION BETWEEN FLOORING MATERIALS OF VARYING HEIGHTS. PROVIDE TRANSITION STRIPS AS INDICATED ON MATERIAL SCHEDULE.

F

DIFFERENT FLOOR MATERIALS ADJACENT TO EACH OTHER ARE TO BE FLUSH. FEATHER AND ALIGN AS REQUIRED.

G

TRANSITION STRIPS TO BE PROVIDED AT JOINT OF DIFFERING MATERIALS.

H

LOCATE ALL FLOORING TRANSITIONS UNDER DOORS.

KEY NOTES

1

EXPANSION JOINT. SEE DETAIL 3/AS-501

2

TRANSITION STRIP AT DOOR THRESHOLD. SEE DETAIL 2/AS-501

3

CONTRACTOR TO PROVIDE SHOP DRAWINGS OF FLOOR TILE LAYOUT, UNO, COORDINATE POSITION AND DIMENSIONS OF FLOOR TILE AREAS WITH C.O.R.

4

DEDUCTIVE ALTERNATE NO.2 - PROVIDE RESILIENT SHEET FLOORING AS SHOWN. INSTALL COVE BASE PER DETAIL 7/AS-501. SEE SHEET AS-102 FOR DEDUCTIVE ALTERNATE NO.1.

KEY PLAN

BUILDING IS FULLY SPRINKLERED

Drawing Title
FLOOR FINISH PLAN - DEDUCTIVE ALTERNATE NO. 2

Location
**CAPTAIN JAMES A. LOVELL FHCC
3001 GREEN BAY ROAD
NORTH CHICAGO, IL 60064**

Project Name
REPLACE SURGICAL FLOORING

Project Number
556-13-106

Date
AUGUST 7, 2013

Drawing Number
133-AS-103

Dwg. of

Building Number
133-2C

Checked
RHC

Drawn
RAT

Approved: Assistant Director

Approved: Chief of Staff

Approved: Chief, Engineering

Approved: Service Chief

Approved: Service Chief

Approved: Service Chief

Approved: Chief, Bio-Med

Approved: Chief, EMS

Approved: Chief, Infection Control

Approved: Chief, IT

Approved: Chief, M&O

Approved: Chief, Police

Approved: Chief, Safety

Approved: Chief

Approved: Chief

CONSULTANTS:

ARCHITECT/ENGINEERS:
COX DESIGN ASSOCIATES
ARCHITECTURE PLANNING INTERIORS
Austin 5121 Bee Caves Road, Suite 203 Chicago 345 N. Canal St. Suite 701
Austin, Texas 78746 Chicago, IL 60605
T:512 - 327 - 4149 T:312 - 698 - 3880
F:512 - 327 - 7679 F:312 - 454 - 9439
coxdesign@austin.rr.com bc Cox@coxtd.com

Revisions:

Date


VA FORM 08-6231

Office of Construction and Facilities Management

Department of Veterans Affairs

A
B
C
D
E
F

three inches = one foot
one and one half inches = one foot
one inch = one foot
three quarters inch = one foot
one half inch = one foot
one quarter inch = one foot
three eighths inch = one foot
one eighth inch = one foot

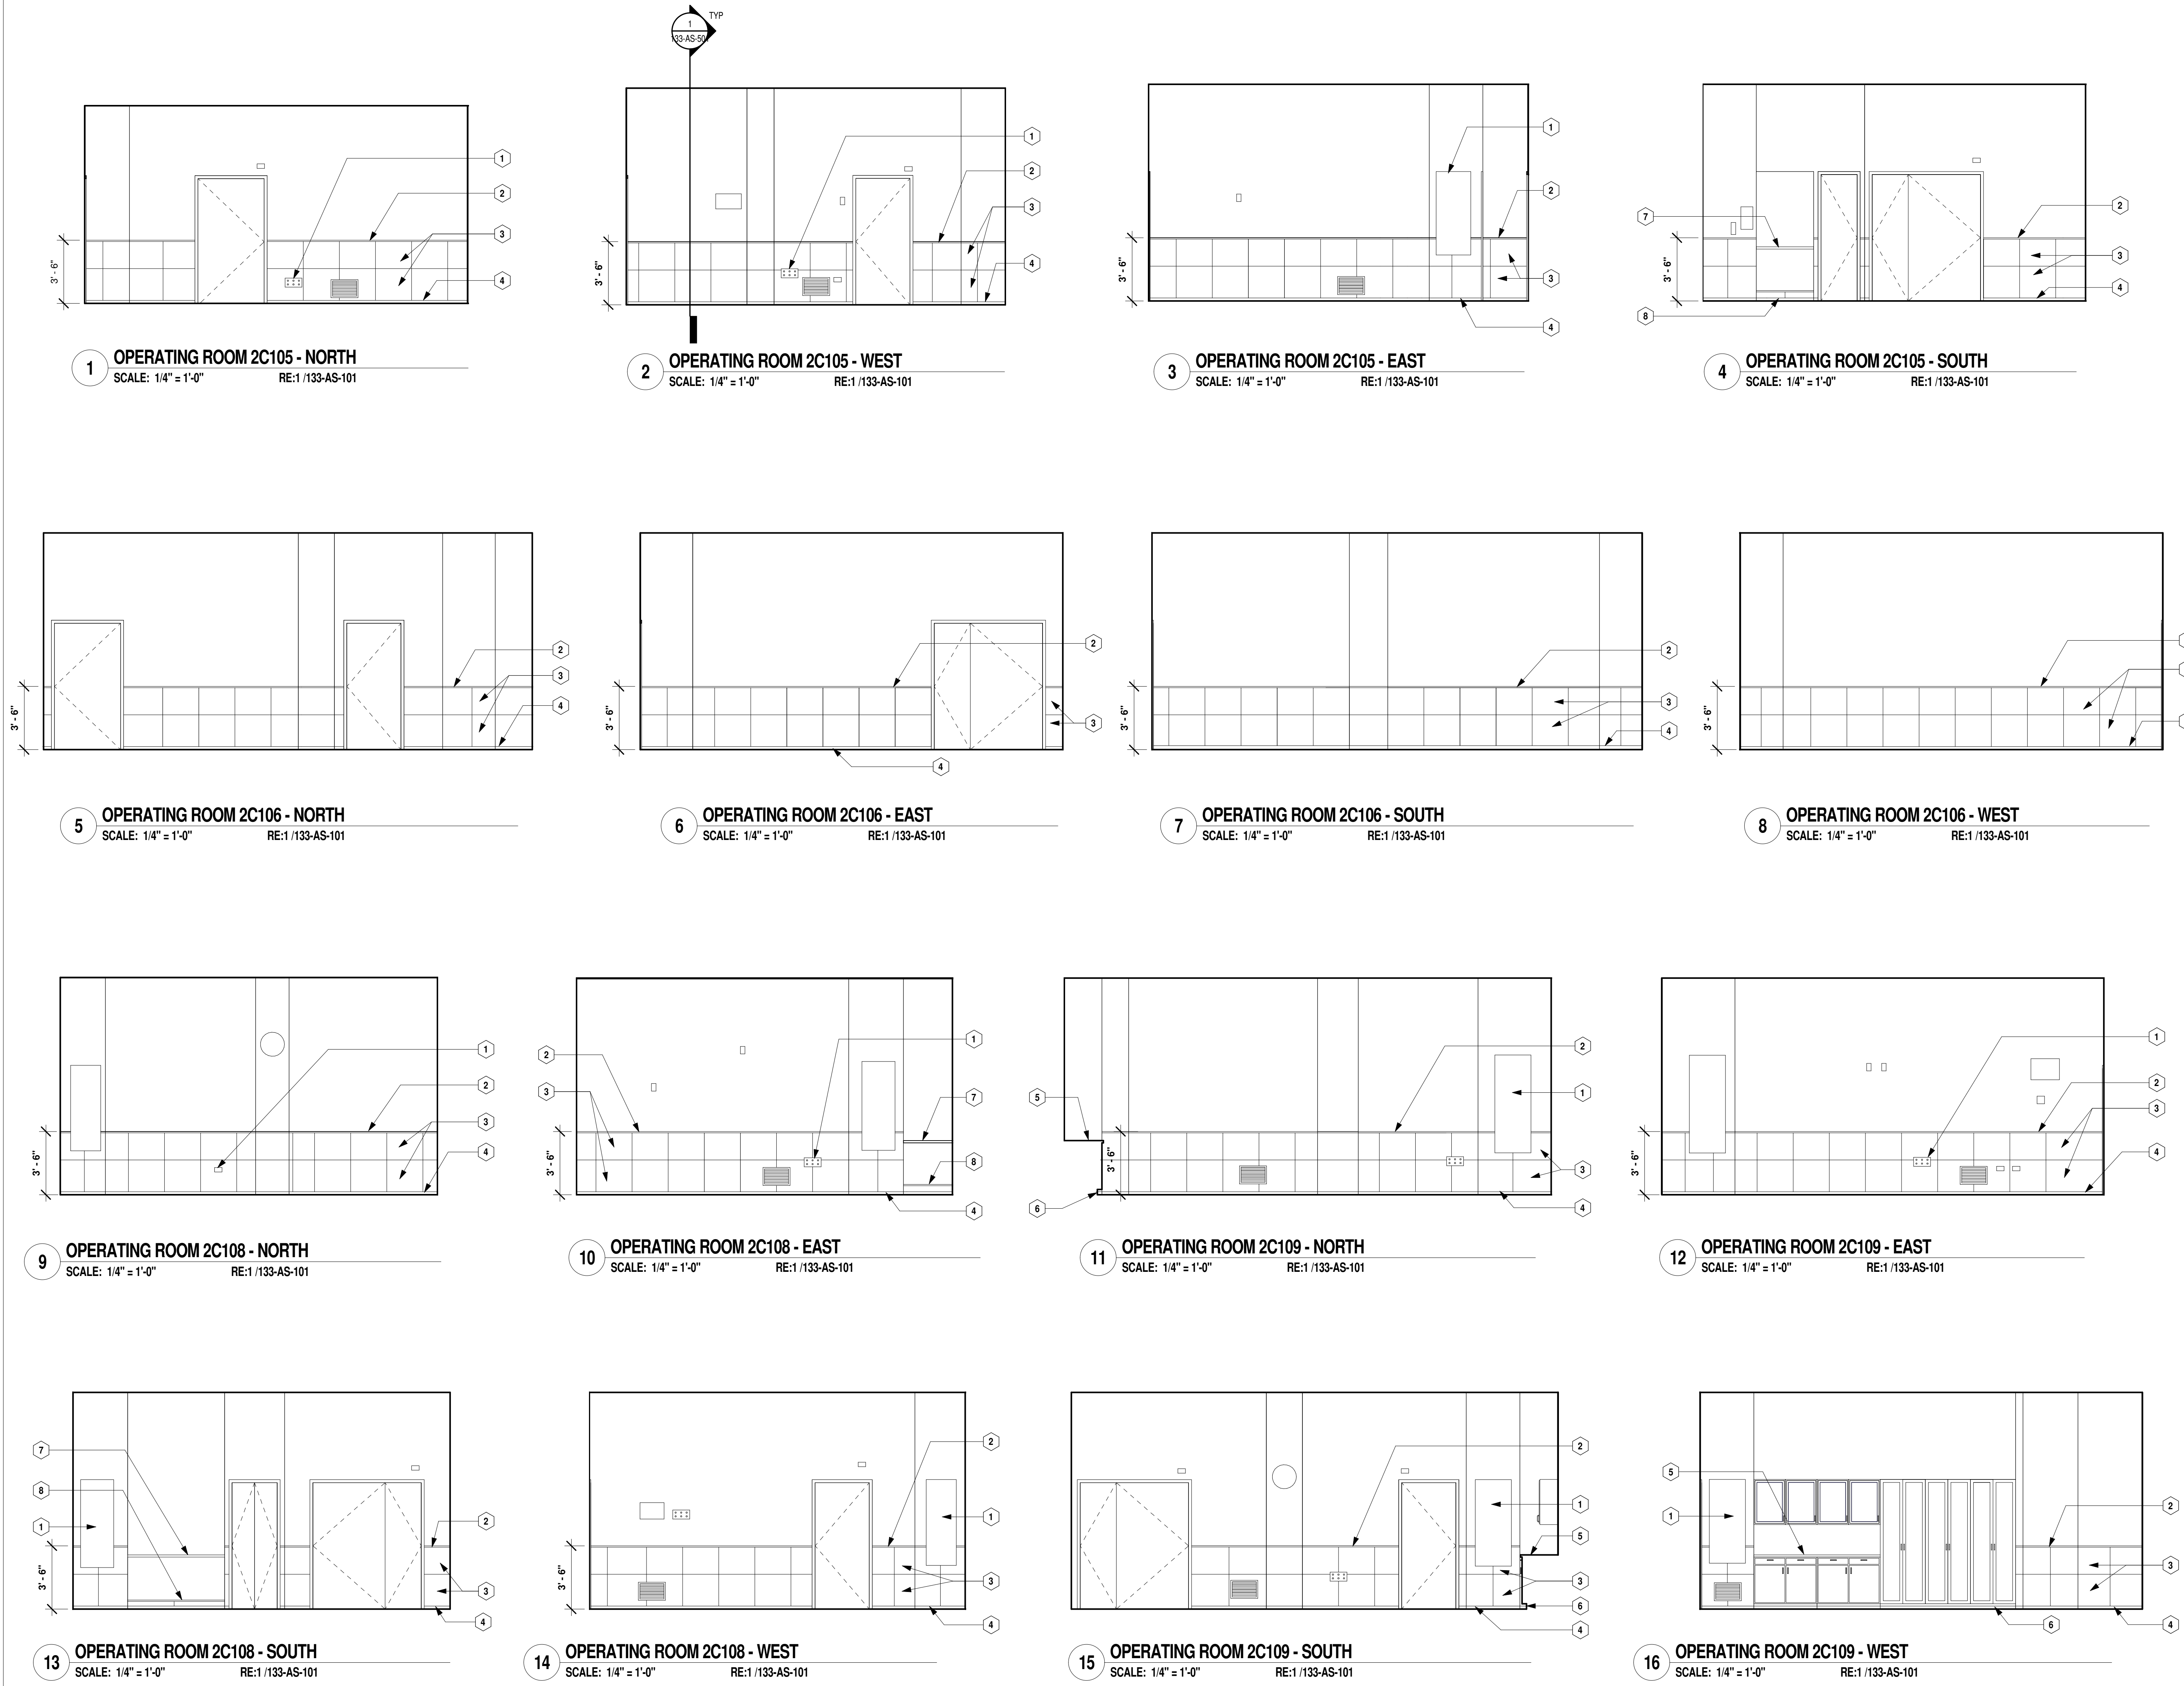

GENERAL NOTES

1. VERIFY ALL DIMENSIONS AND CONDITIONS AY JOB SITE.
2. UNLESS NOTED TO BE REMOVED AND DISPOSED, ALL EXISTING ITEMS ARE TO REMAIN. THEY SHALL BE PROTECTED FROM DAMAGE DUE TO CONSTRUCTION ACTIVITIES. ANY EXISTING ITEMS TO REMAIN THAT BECOME DAMAGED DUE TO CONSTRUCTION ACTIVITIES SHALL BE REPAIRED OR REPLACED TO MATCH EXISTING AT NO ADDITIONAL COST TO THE OWNER..
3. MAINTAIN CONTINUOUS UTILITY SERVICE TO ALL SPACES IN THE BUILDING NOT AFFECTED BY THIS WORK. COORDINATE WITH OWNER ANY DISRUPTION IN SERVICES REQUIRED TO PERFORM WORK OR TO MODIFY EXISTING PIPING, DUCTWORK, OR ANY ASSOCIATED EQUIPMENT.
4. THE GENERAL CONTRACTOR SHALL REPORT ANY UNFORESEEN FIELD CONDITIONS, ERRORS, INCONSISTENCIES, OR OMISSIONS DISCOVERED AT ANY TIME DURING THE WORK. UPON SUCH DISCOVERY, THE CONTRACTOR SHALL IMMEDIATELY CONTACT THE C.O.R. FOR CLARIFICATION BEFORE PROCEEDING OR CONTINUING WITH THAT PORTION OF THE WORK OR ANY PORTION RELATED THERE TO.
5. ALL WORK SHALL CONFORM TO ALL APPLICABLE CODES AND STANDARDS INCLUDING THE INTERNATIONAL BUILDING CODE 2012 EDITION, VA MASTER SPECIFICATIONS, AND NFPA 101 2012 EDITION.
6. CONTRACTOR SHALL NOT BARRICADE / BARRIER EMERGENCY EGRESS TO OR FROM THIS AREA. CONTRACTOR SHALL MAINTAIN EXIT TO EXTERIOR DURING THE WORK PROCESS
7. PROVIDE ACCESS TO THE WORK AS DIRECTED BY THE C.O.R. SECURE ACCESS POINT AS SPECIFIED AND DIRECTED BY THE COR. PROVIDE WALK-OFF MATS TO MEET FACILITY INFECTION CONTROL GUIDELINES AT EACH ACCESS POINT.
8. SHADED AREAS ARE GENERALLY OUT OF SCOPE FOR THIS PROJECT.
9. NOTATIONS FOR ITEMS OF WORK APPLY TO EACH AND EVERY GRAPHICAL INDICATION SHOWN ON THE DRAWINGS, WETHER OR NOT NOTED.
10. THE GENERAL CONTRACTOR SHALL VISIT THE SITE, VERIFY FIELD CONDITIONS AND CAREFULLY COMPARE SUCH FIELD CONDITIONS AND OTHER INFORMATION KNOWN TO THE CONTRACTOR WITH CONTRACT DOCUMENTS.
11. THE GENERAL CONTRACTOR SHALL REPORT ANY UNFORESEEN FIELD CONDITIONS, ERRORS, INCONSISTENCIES, OR COMMISSIONS DISCOVERED AT ANY TIME DURING THE WORK. UPON SUCH DISCOVERY, THE CONTRACTOR SHALL IMMEDIATELY CONTRACT THE ARCHITECT AND COR FOR CLARIFICATION BEFORE PROCEEDING OR CONTINUING WITH THAT PORTION OF THE WORK OR ANY PORTION RELATED THERE TO.
12. THE GENERAL CONTRACTOR SHALL NOTIFY THE COR AND THE ARCHITECT OF ANY DISCREPANCIES BETWEEN THE DRAWINGS, NOTES AND ACTUAL FIELD CONDITIONS BEFORE BIDDING AND COMMENCING ANY WORK, AND REQUEST CLARIFICATION IN WRITING.
13. WORK SHALL BE PERFORMED DURING THE FOLLOWING HOURS:
MONDAY THROUGH THURSDAY - 1800 TO 0500 EACH DAY
WEEKENDS - FRIDAY 1800 TO MONDAY 0500
14. FHCC ACCESS TO, AND USE OF, OPERATING ROOMS NOT UNDER CONSTRUCTION MUST BE MAINTAINED AT ALL TIMES. SEE DETAIL 6/AS-501 FOR TEMPORARY CONSTRUCTION WALL.

SHEET NOTES


- INTERIOR ELEVATION NOTES:**
- A SEE PROJECT FINISH REFERENCE, SHEET 1-AS601 FOR FINISHES, MATERIALS, AND COLORS FOR: WALLS, DOOR, WALL PROTECTION DEVICES, HANDRAILS, BASE, TILE, AND GROUT.
 - B INTERIOR ELEVATIONS ARE FOR THE PURPOSE OF SHOWING TERRAZZO TILE WAINSCOT ONLY.

KEY NOTES


- ① ALL EXISTING WALL MOUNTED ITEMS AND DEVICES PENETRATING THE WALL OR MOUNTED ON THE WALL SURFACE ARE TO BE PROPERLY SECURED AND MOUNTED FOR THE INSTALLATION OF NEW TERRAZZO TILE WAINSCOT.
- ② VINYL WAINSCOT CAP
- ③ TERRAZZO TILE WAINSCOT.
- ④ TERRAZZO TILE COVE BASE
- ⑤ EXISTING CASEWORK. DO NOT INSTALL WAINSCOT AT THIS LOCATION.
- ⑥ REFER TO DETAIL 10/AS-501 FOR BASE COVE DETAIL AT CASEWORK.
- ⑦ EXISTING BUILT IN DESK. DO NOT INSTALL WAINSCOT AT THIS LOCATION.
- ⑧ REFER TO DETAIL 9/AS-501 FOR COVE BASE DETAIL AT BUILT IN DESK.

**BUILDING IS
FULLY
SPRINKLERED**

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4 TYPICAL JOINT DETAIL @ ANGLED CORNERS
SCALE: 3" = 1'-0"

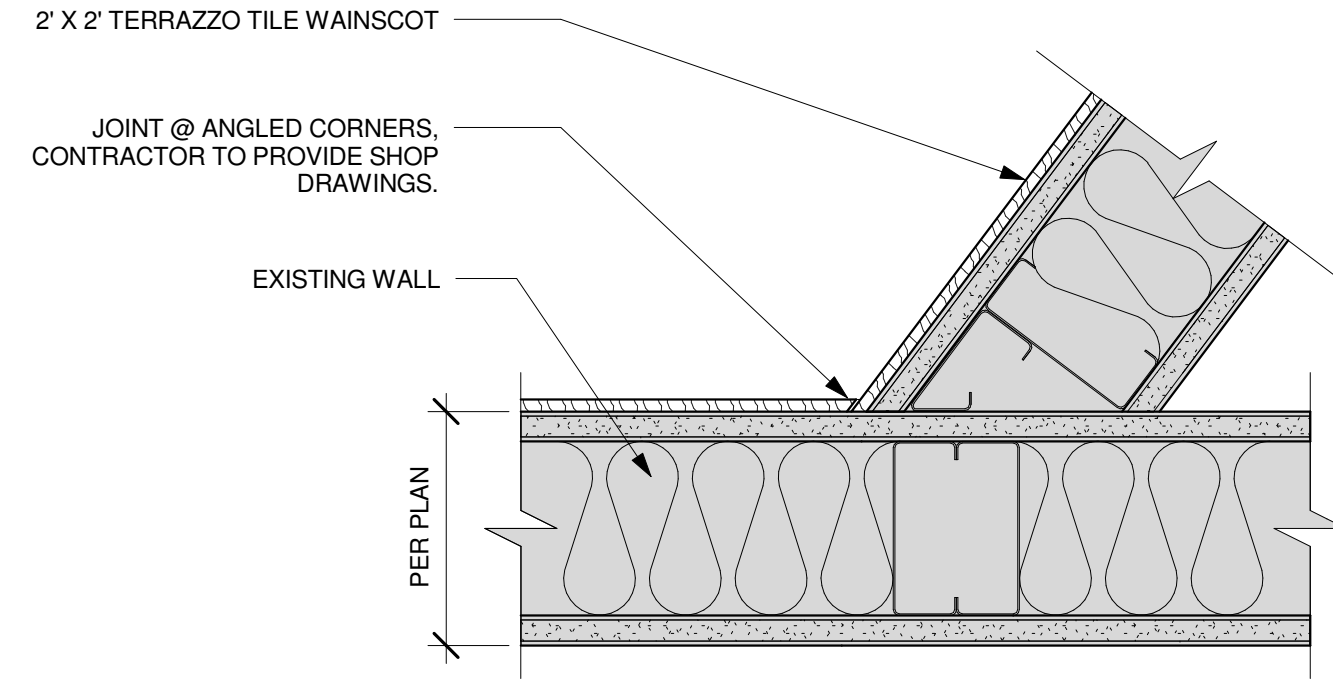

8 RESILIENT SHEET FLOORING COVE BASE DETAIL @ EXISTING CORNER GUARD
SCALE: 3" = 1'-0"

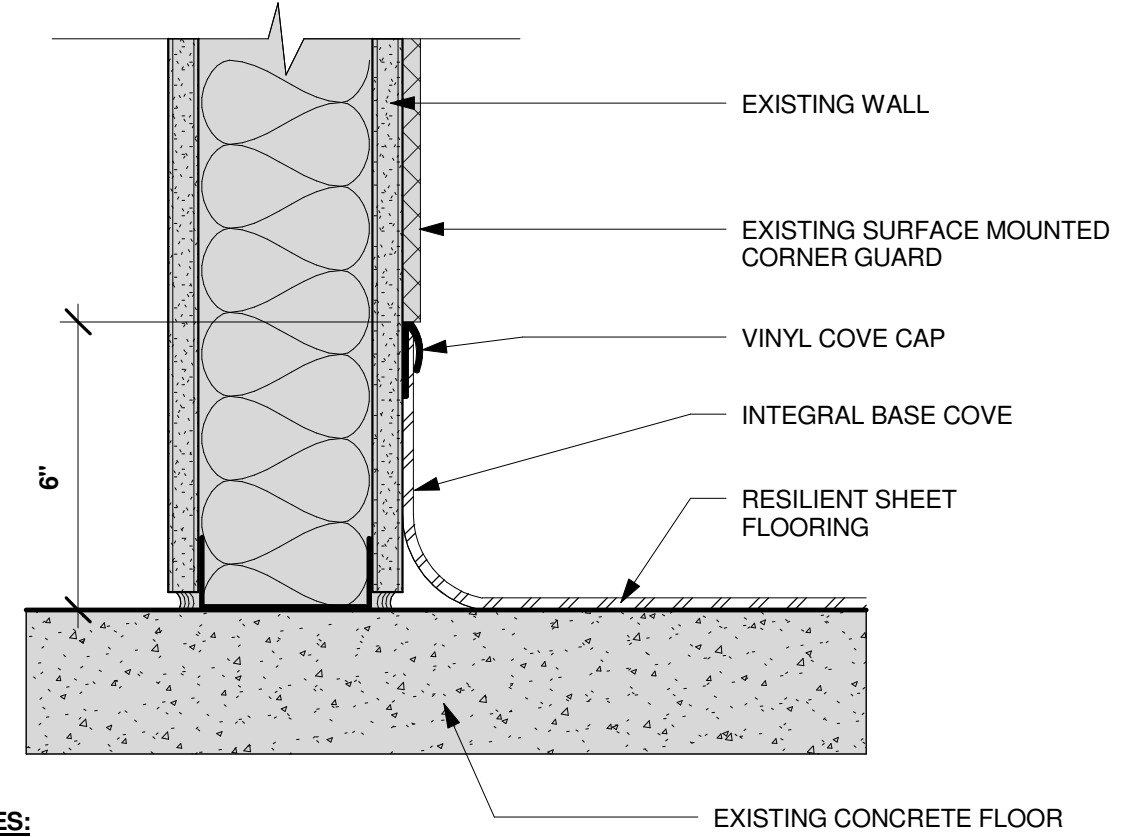10 TERRAZZO TILE COVE BASE @ EXISTING CASEWORK
SCALE: 3" = 1'-0"

ROOM FINISH SCHEDULE

ROOM NUMBER	ROOM NAME	FLOOR	BASE	ROOM FINISH SCHEDULE							CEILING	WINDOW TREATMENTS	ID FINISH REMARK
				WALLS									
				NORTH	EAST	SOUTH	WEST						
2C102		SV-1	SV-1/TS-2							N/A	N/A	BASE 6" HIGH	
2C102A		SV-1	SV-1/TS-2							N/A	N/A	BASE 6" HIGH	
2C102B		SV-1	SV-1/TS-2							N/A	N/A	BASE 6" HIGH	
2C105	OPERATING ROOM 1	FT-1/FT-2/FT-3	FB-1	FT-4/TS-3	FT-4/TS-3	FT-4/TS-3	FT-4/TS-3			N/A	N/A	WAINSCOT 42" HIGH	
2C105B		FT-1	FB-1	FT-4/TS-3	FT-4/TS-3	FT-4/TS-3	FT-4/TS-3			N/A	N/A	WAINSCOT 42" HIGH	
2C106	OPERATING ROOM 2	FT-1/FT-2/FT-3	FB-1	FT-4/TS-3	FT-4/TS-3	FT-4/TS-3	FT-4/TS-3			N/A	N/A	WAINSCOT 42" HIGH	
2C107		SV-1	SV-1/TS-2							N/A	N/A	WAINSCOT 42" HIGH	
2C108	OPERATING ROOM 4	FT-1/FT-2/FT-3	FB-1	FT-4/TS-3	FT-4/TS-3	FT-4/TS-3	FT-4/TS-3			N/A	N/A	WAINSCOT 42" HIGH	
2C108A		FT-1	FB-1	FT-4/TS-3	FT-4/TS-3	FT-4/TS-3	FT-4/TS-3			N/A	N/A	WAINSCOT 42" HIGH	
2C109	OPERATING ROOM 3	FT-1/FT-2/FT-3	FB-1	FT-4/TS-3	FT-4/TS-3	FT-4/TS-3	FT-4/TS-3			N/A	N/A	WAINSCOT 42" HIGH	
2C109A		FT-1	FB-1	FT-4/TS-3	FT-4/TS-3	FT-4/TS-3	FT-4/TS-3			N/A	N/A	WAINSCOT 42" HIGH	
2C110		SV-1	SV-1/TS-2							N/A	N/A	BASE 6" HIGH	
2C110A		SV-1	SV-1/TS-2							N/A	N/A	BASE 6" HIGH	
2C111		SV-1	SV-1/TS-2							N/A	N/A	BASE 6" HIGH	
C2220	CORR	FT-1/FT-2	FB-1	FT-4/TS-3	FT-4/TS-3	FT-4/TS-3	FT-4/TS-3			N/A	N/A	WAINSCOT 42" HIGH	
C2221	CORR	FT-1/FT-2	FB-1	FT-4/TS-3	FT-4/TS-3	FT-4/TS-3	FT-4/TS-3			N/A	N/A	WAINSCOT 42" HIGH	
C2222	CORR	FT-1/FT-2	FB-1	FT-4/TS-3	FT-4/TS-3	FT-4/TS-3	FT-4/TS-3			N/A	N/A	WAINSCOT 42" HIGH	
C2223	CORR	FT-1/FT-2	FB-1	FT-4/TS-3	FT-4/TS-3	FT-4/TS-3	FT-4/TS-3			N/A	N/A	WAINSCOT 42" HIGH	
C2224	CORR	FT-1/FT-2	FB-1	FT-4/TS-3	FT-4/TS-3	FT-4/TS-3	FT-4/TS-3			N/A	N/A	WAINSCOT 42" HIGH	
C2225	CORR	FT-1/FT-2	FB-1	FT-4/TS-3	FT-4/TS-3	FT-4/TS-3	FT-4/TS-3			N/A	N/A	WAINSCOT 42" HIGH	
C2226	CORR	FT-1/FT-2	FB-1	FT-4/TS-3	FT-4/TS-3	FT-4/TS-3	FT-4/TS-3			N/A	N/A	WAINSCOT 42" HIGH	
C2227	CORR	FT-1/FT-2	FB-1	FT-4/TS-3	FT-4/TS-3	FT-4/TS-3	FT-4/TS-3			N/A	N/A	WAINSCOT 42" HIGH	
C2228	CORR	FT-1/FT-2	FB-1	FT-4/TS-3	FT-4/TS-3	FT-4/TS-3	FT-4/TS-3			N/A	N/A	WAINSCOT 42" HIGH	
C2229	CORR	FT-1/FT-2	FB-1	FT-4/TS-3	FT-4/TS-3	FT-4/TS-3	FT-4/TS-3			N/A	N/A	WAINSCOT 42" HIGH	

MATERIAL FINISH LEGEND

[illegible]

BASE FINISH LEGEND

FINISH CODE	MATERIAL	MANUFACTURER	MANUFACTURER NO.	PATTERN	COLOR	SIZE	BASE GROUT KEY	ID FINISH REMARKS
FB-1	TERRAZZO TILE COVE BASE	MATS, INC.		FLOORAZZO	---			
SV-1	RESILIENT SHEET FLOORING	ARMSTRONG OR EQUAL		MENDINTONE	MATCH FT-1	N/A		
TS-2	COVE BASE CAP	JOHNSONITE OR EQUAL		N/A	MATCH SV-1			

WALL FINISH LEGEND

[illegible]

GENERAL FINISH NOTES

1. WHERE TERRAZZO TILE MEETS RESILIENT SHEET FLOORING, PROVIDE TRANSITIONAL EDGE STRIP. ALIGN STRIP UNDER CENTER OF DOOR.
2. MANUFACTURER'S TRADE NAMES AND NUMBERS USED HEREIN FOR SOME PRODUCTS ARE ONLY TO IDENTIFY COLORS, FINISHES, TEXTURES AND PATTERNS. PRODUCTS OF OTHER MANUFACTURERS EQUIVALENT TO COLORS, FINISHES, TEXTURES AND PATTERNS OF MANUFACTURERS LISTED THAT MEET REQUIREMENTS OF TECHNICAL SPECIFICATIONS WILL BE ACCEPTABLE, UPON APPROVAL, IN WRITING, BY THE COR FOR FINISH REQUIREMENTS. OTHER PROPRIETARY PRODUCTS ARE SPECIFIED BY MANUFACTURER'S TRADE NAME.
3. FOR THE FINISH LOCATION INFORMATION REFER TO THE FINISH SCHEDULE DRAWINGS.
4. WORK SHALL BE PERFORMED DURING THE FOLLOWING HOURS:
MONDAY THROUGH THURSDAY - 1800 TO 0500 EACH DAY
WEEKENDS - FRIDAY 1800 TO MONDAY 0500.

OWNER PROVIDED ITEMS

[illegible]

**BUILDING IS
FULLY
SPRINKLERED**

[illegible]